

	NORTH WEST CROWN					
POINT	NORTHING	EASTING	ELEVATION	DESCRIPTION		
P1	9999.00	9999.00	150.00'	PC/PT/PI/MID/PCC/PRC		
P2						
P3						
P4						
P5						
	-					

		NORTH WE	ST LIP	
POINT	NORTHING	EASTING	ELEVATION	DESCRIPTION
P1	9999.00	9999.00	150.00'	PC/PT/PI/MID/PCC/PRC
P2				
P3				
P4				
P5				

	EAST ISLAND LIP					
POINT	NORTHING	EASTING	ELEVATION	DESCRIPTION		
P1	9999.00	9999.00	150.00'	PC/PT/PI/MID/PCC/PRC		
P2						
P3						
P4						
P5						

SOUTH WEST CROWN					
POINT	NORTHING	EASTING	ELEVATION	DESCRIPTION	
P1	9999.00	9999.00	150.00'	PC/PT/PI/MID/PCC/PRC	
P2					
P3					
P4					
P5					

SOUTH WEST LIP					
POINT	NORTHING	EASTING	ELEVATION	DESCRIPTION	
P1	9999.00	9999.00	150.00'	PC/PT/PI/MID/PCC/PRC	
P2					
P3					
P4					
P5					

	SOUTH ISLAND LIP				
POINT	NORTHING	EASTING	ELEVATION	DESCRIPTION	
P1	9999.00	9999.00	150.00'	PC/PT/PI/MID/PCC/PRC	
P2					
P3					
P4					
P5					

	SOUTH EAST CROWN						
POINT	NORTHING	EASTING	ELEVATION	DESCRIPTION			
P1	9999.00	9999.00	150.00'	PC/PT/PI/MID/PCC/PRC			
P2							
P3							
P4							
P5							

	SOUTH EAST LIP				
POINT	NORTHING	EASTING	<i>ELEVATION</i>	DESCRIPTION	
P1	9999.00	9999.00	150.00'	PC/PT/PI/MID/PCC/PRC	
P2					
P3					
P4					
P5					

		NORTH ISLA	AND LIP	
POINT	NORTHING	EASTING	ELEVATION	DESCRIPTION
P1	9999.00	9999.00	150.00'	PC/PT/PI/MID/RCC/PR
P2				
P3				
P4				
P5				
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SOUTH WEST CROWN					
POINT	NORTHING	EASTING	ELEVATION	DESCRIPTION	
P1	9999.00	9999.00	150.00'	PC/PT/PI/MID/PCC/PRC	
P2					
P3					
P4					
P5					

	SOUTH WEST LIP					
POINT	NORTHING	EASTING	ELEVATION	DESCRIPTION		
P1	9999.00	9999.00	150.00'	PC/PT/PI/MID/PCC/PRC		
P2						
P3						
P4						
P5						

DRAWN CHECKED REV DATE FIELD BOOKS LOCATION DESCRIPTION DESCRIPTION BM NO. ELEV. DATA DATA BY REV DATE TELEPHONE ELECTRIC TOPOGRAPHY CABLE TV
DESIGN
QUANTITIES PROFILE SANITARY SEWER STORM SEWER BASIS OF THIS DATUM WATER MUN. FINAL CHK. VERTICAL DATUM

**78M** 

R&M Consultants, Inc. 9101 Vanguard Drive Anchorage, Alaska 99507 907 522 1707 voice 907 522 3404 fax www.rmconsult.com





05 WEST DIMOND BOULEVARD UPGRADE PHASE I: WESTPARK DRIVE TO SAND LAKE ROAD

**GRADING TABLES WESTPARK ROUNDABOUT GRADING** 

DATE 4/11/14 GRID 2323 2324 SHEET 43 of 76 SCALE

	ROUNDABOUT POINTS					
POINT	NORTHING	EASTING	ELEVATION	DESCRIPTION		
RP1	9999.00	9999.00	150.00'	PC/PT/PI/MID/PCC/PRC		
RP2	9999.00	9999.00	150.00'	PC/PT/PI/MID/PCC/PRC		
RP3	9999.00	9999.00	150.00'	PC/PT/PI/MID/PCC/PRC		
RP4	9999.00	9999.00	150.00'	PC/PT/PI/MID/PCC/PRC		
RP5	9999.00	9999.00	150.00'	PC/PT/PI/MID/PCC/PRC		

37																		
	FIELD BOOKS	BM NO. LOCATION	ELEV.	DATA	DRAWN BY	CHECKED BY	DATA	DRAWN BY	CHECKEL	REV	DATE	DESCRIPTION	BY	REV	DATE	DESCRIPTION	BY	
4	DESIGN			BASE			TELEPHONE											
Š				TOPOGRAPHY			ELECTRIC											
	STAKING			PROFILE			CABLE TV											,
Ė				SANITARY SEWER			DESIGN											An
4	ASBUILT			STORM SEWER			QUANTITIES											
ij	CONTRACTOR	BASIS OF THIS DATUM		WATER			MUN. FINAL CHK											
£	INSPECTOR			GAS														
0	CONSTRUCTION RECORD	VERTICAL DATUM				OI AN	CHECK			$\Gamma$		·	REVI	SIONS	;	·		

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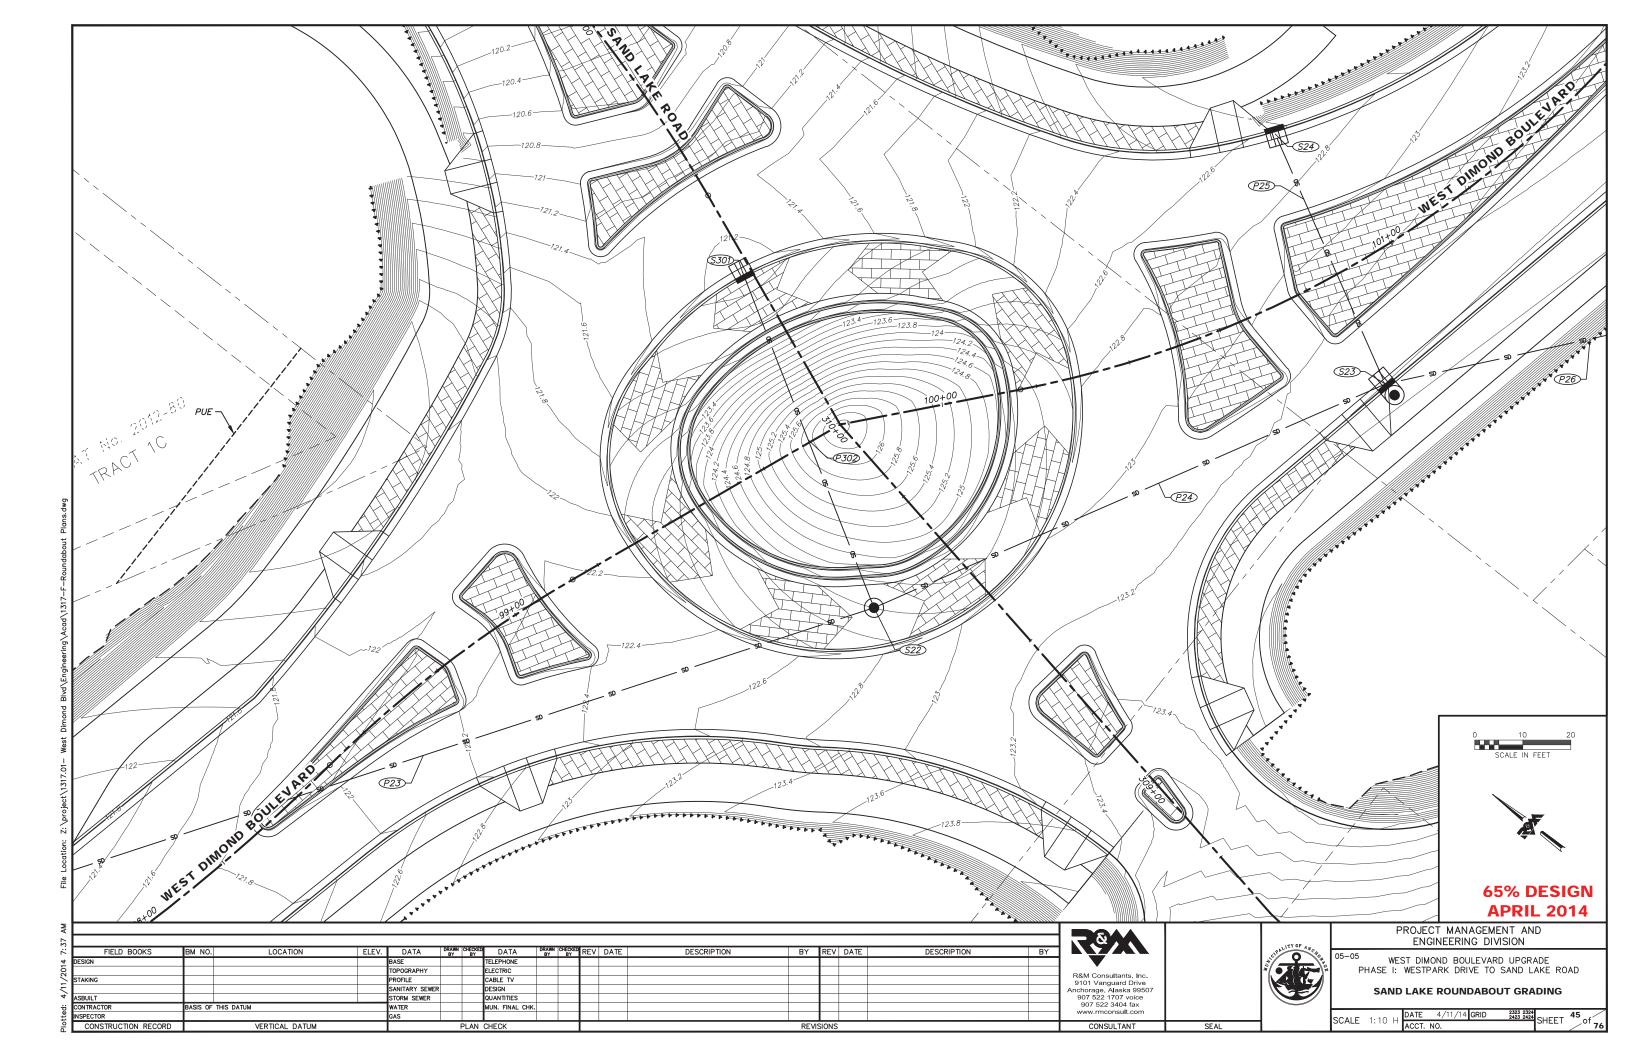
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PROJECT MANAGEMENT AND ENGINEERING DIVISION

<sup>05</sup> WEST DIMOND BOULEVARD UPGRADE PHASE I: WESTPARK DRIVE TO SAND LAKE ROAD

GRADING TABLES **WESTPARK ROUNDABOUT GRADING** 

ALE	DATE	4/11/14 GRID	2323 2324 2423 2424 CHEET	44/
ALE	ACCT.	NO.	SHEET	/ <sup>01</sup> 76



	NORTH WEST CROWN									
POINT	NORTHING	EASTING	ELEVATION	DESCRIPTION						
P1	9999.00	9999.00	150.00'	PC/PT/PI/MID/PCC/PRC						
P2										
P3										
P4										
P5										

		NORTH WE	ST LIP	
POINT	NORTHING	EASTING	ELEVATION	DESCRIPTION
P1	9999.00	9999.00	150.00'	PC/PT/PI/MID/PCC/PRC
P2				
P3				
P4				
P5				

	EAST ISLAND LIP								
POINT	NORTHING	EASTING	ELEVATION	DESCRIPTION					
P1	9999.00	9999.00	150.00'	PC/PT/PI/MID/PCC/PRC					
P2									
P3									
P4									
P5									

		SOUTH WEST	CROWN	
POINT	NORTHING	EASTING	ELEVATION	DESCRIPTION
P1	9999.00	9999.00	150.00'	PC/PT/PI/MID/PCC/PRC
P2				
P3				
P4				
P5				

		SOUTH WE	ST LIP	
POINT	NORTHING	EASTING	ELEVATION	DESCRIPTION
P1	9999.00	9999.00	150.00'	PC/PT/PI/MID/PCC/PRC
P2				
P3				
P4				
P5				

	SOUTH ISLAND LIP								
POINT	NORTHING	EASTING	ELEVATION	DESCRIPTION					
P1	9999.00	9999.00	150.00'	PC/PT/PI/MID/PCC/PRC					
P2									
P3									
P4									
P5									

		SOUTH EAST	CROWN	
POINT	NORTHING	EASTING	ELEVATION	DESCRIPTION
P1	9999.00	9999.00	150.00'	PC/PT/PI/MID/PCC/PRC
P2				
P3				
P4				
P5				

	SOUTH EAST LIP								
POINT	NORTHING	EASTING	ELEVATION	DESCRIPTION					
P1	9999.00	9999.00	150.00'	PC/PT/PI/MID/PCC/PRC					
P2									
P3									
P4									
P5									

		NORTH ISLA	ND LIP	
POINT	NORTHING	EASTING	ELEVATION	DESCRIPTION
P1	9999.00	9999.00	150.00'	PC/PT/PI/MID/RCC/PRO
P2				
P3				
P4				
P5				
	•			•

SOUTH WEST CROWN										
POINT	NORTHING	EASTING	ELEVATION	DESCRIPTION						
P1	9999.00	9999.00	150.00'	PC/PT/PI/MID/PCC/PRC						
P2										
P3										
P4										
P5										


		SOUTH WE	ST LIP	
POINT	NORTHING	EASTING	ELEVATION	DESCRIPTION
P1	9999.00	9999.00	150.00'	PC/PT/PI/MID/PCC/PRC
P2				
P3				
P4				
P5				

DRAWN CHECKED REV DATE FIELD BOOKS LOCATION DESCRIPTION BY REV DATE DESCRIPTION BM NO. ELEV. DATA DATA TELEPHONE ELECTRIC TOPOGRAPHY CABLE TV
DESIGN
QUANTITIES PROFILE STORM SEWER BASIS OF THIS DATUM WATER MUN. FINAL CHK. VERTICAL DATUM

**78M** 

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WEST DIMOND BOULEVARD UPGRADE
PHASE I: WESTPARK DRIVE TO SAND LAKE ROAD

**GRADING TABLES** SAND LAKE ROUNDABOUT GRADING

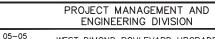DATE 4/11/14 GRID 2323 2324 SHEET 46 of 76 SCALE

DESCRIPTION PT/PI/MID/PCC/PRC PT/PI/MID/PCC/PRC PT/PI/MID/PCC/PRC PT/PI/MID/PCC/PRC PT/PI/MID/PCC/PRC	POINT RP1			POINTS	
T/PI/MID/PCC/PRC T/PI/MID/PCC/PRC T/PI/MID/PCC/PRC	RP1	NORTHING	EASTING	ELEVATION	DESCRIPTION
T/PI/MID/PCC/PRC T/PI/MID/PCC/PRC		9999.00	9999.00	150.00'	PC/PT/PI/MID/PCC/PRC
PI/MID/PCC/PRC	RP2	9999.00	9999.00	150.00'	PC/PT/PI/MID/PCC/PRC
	RP3	9999.00	9999.00	150.00'	PC/PT/PI/MID/PCC/PRC
	RP4	9999.00	9999.00	150.00'	PC/PT/PI/MID/PCC/PRC
	RP5	9999.00	9999.00	150.00'	PC/PT/PI/MID/PCC/PRC
		+			
		-			
		-			

PRAWN CHECKED REV DATE DESCRIPTION FIELD BOOKS LOCATION ELEV. DATA DATA DESCRIPTION BY REV DATE FLECTRIC CABLE TV PROFILE STORM SEWER QUANTITIES BASIS OF THIS DATUM WATER MUN. FINAL CHK. VERTICAL DATUM

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PROJECT MANAGEMENT AND ENGINEERING DIVISION


-05 WEST DIMOND BOULEVARD UPGRADE PHASE I: WESTPARK DRIVE TO SAND LAKE ROAD


GRADING TABLES
SAND LAKE ROUNDABOUT GRADING


SCALE DATE 4/11/14 GRID 2323 2324 SHEET 47 of 76


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Plotted: 4/11/2014 7:37 AM



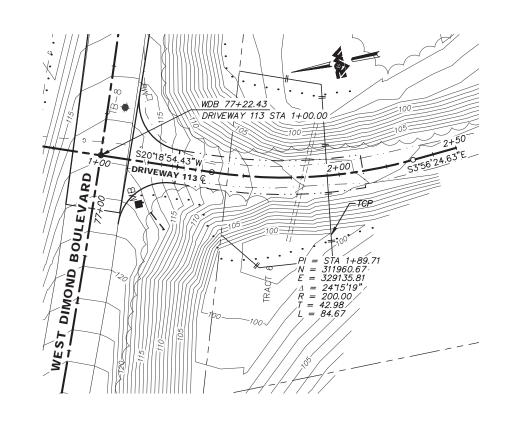

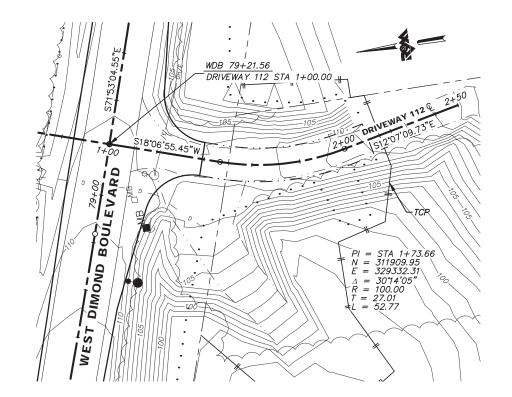

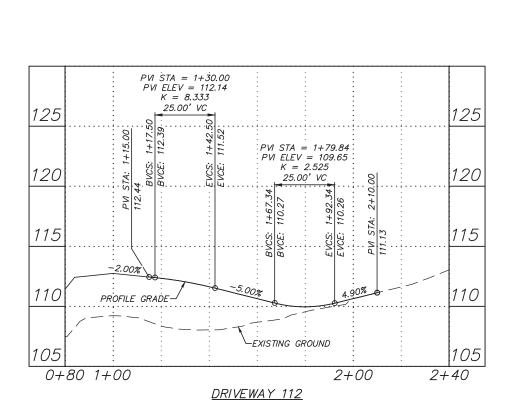
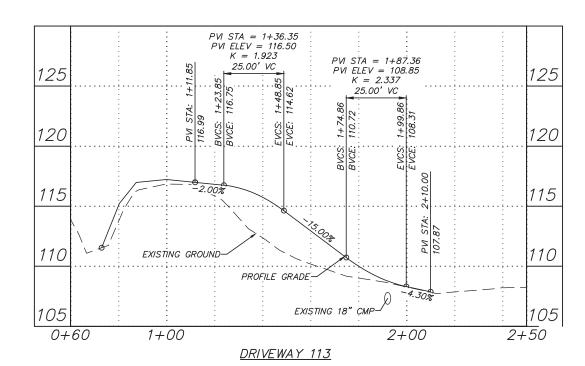
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38		•					•											7
7	FIELD BOOKS	BM NO.	LOCATION	ELEV.	DATA	DRAWN CHECKE BY BY	DATA	DRAWN BY	CHECKED BY	REV	DATE	DESCRIPTION	BY	REV	DATE	DESCRIPTION	BY	7/
4	DESIGN				BASE		TELEPHONE											
20					TOPOGRAPHY		ELECTRIC											R&M
	STAKING		<u> </u>		PROFILE		CABLE TV											9101
Ė					SANITARY SEWER		DESIGN											Anchor
4	ASBUILT				STORM SEWER		QUANTITIES											907
÷	CONTRACTOR	BASIS OF	THIS DATUM		WATER		MUN. FINAL CHK.											90°
ŧ	INSPECTOR		<u> </u>		GAS								-					· · · · · · · · · · · · · · · · · · ·
B <sub>0</sub>	CONSTRUCTION RECORD		VERTICAL DATUM	·		PLAN	CHECK						REVI	ISIONS	5	·		

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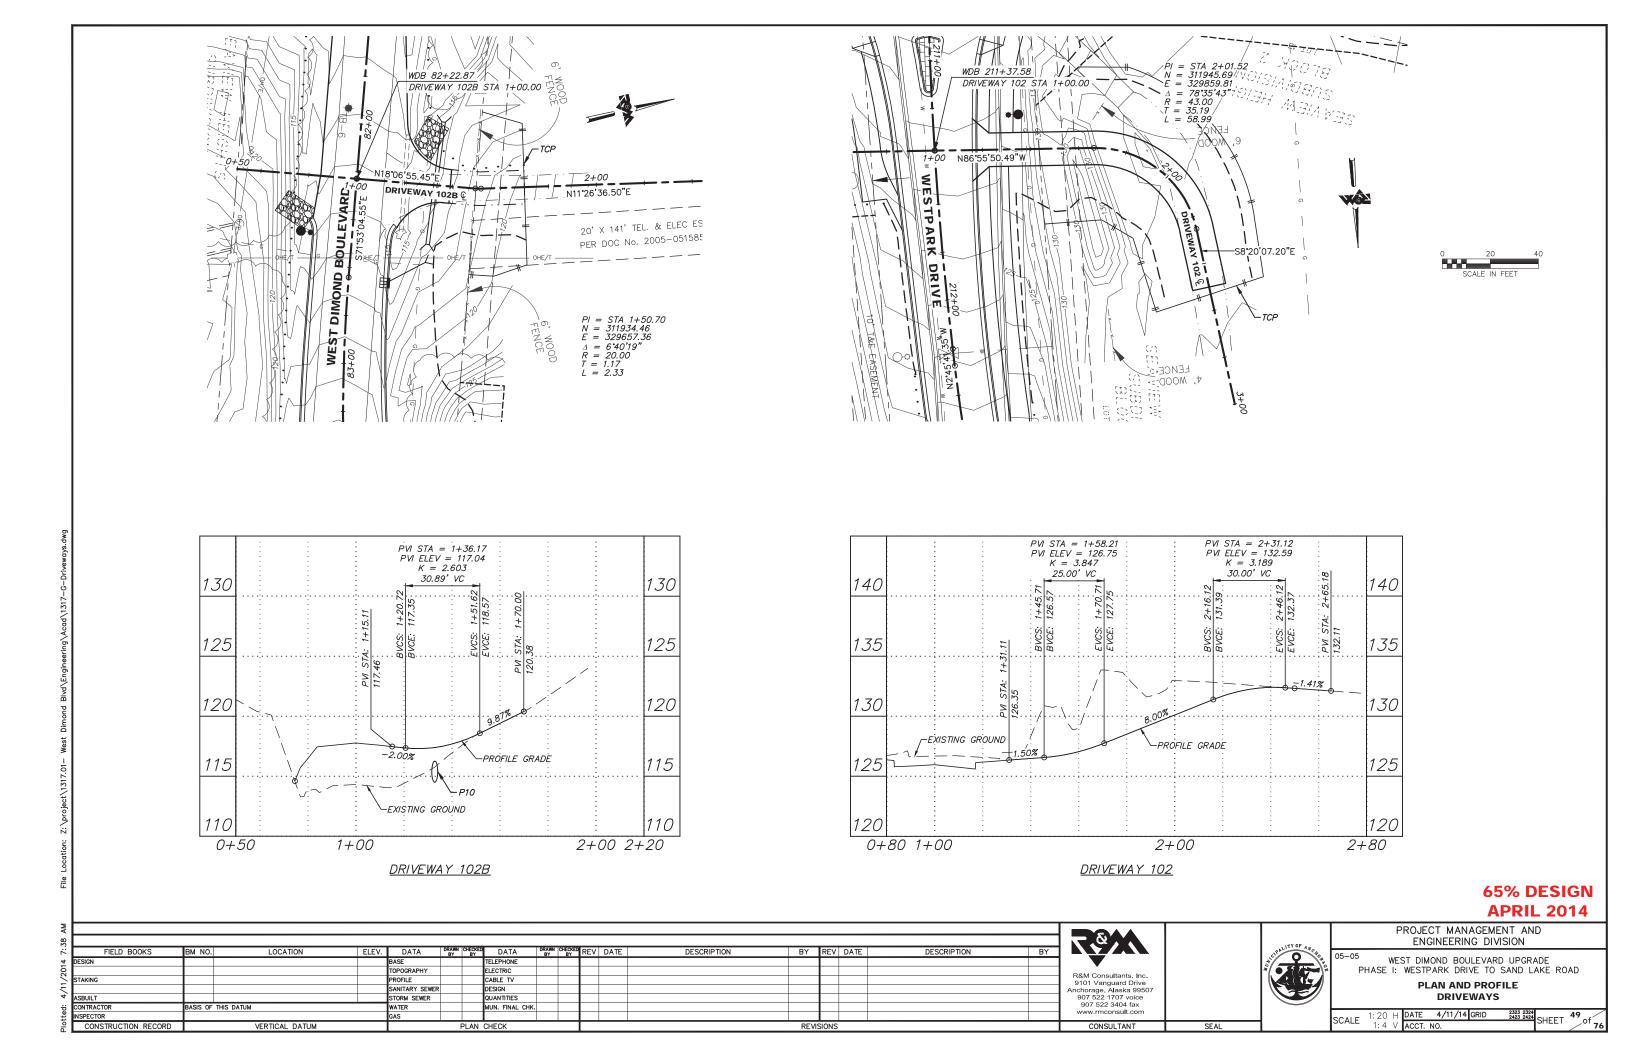
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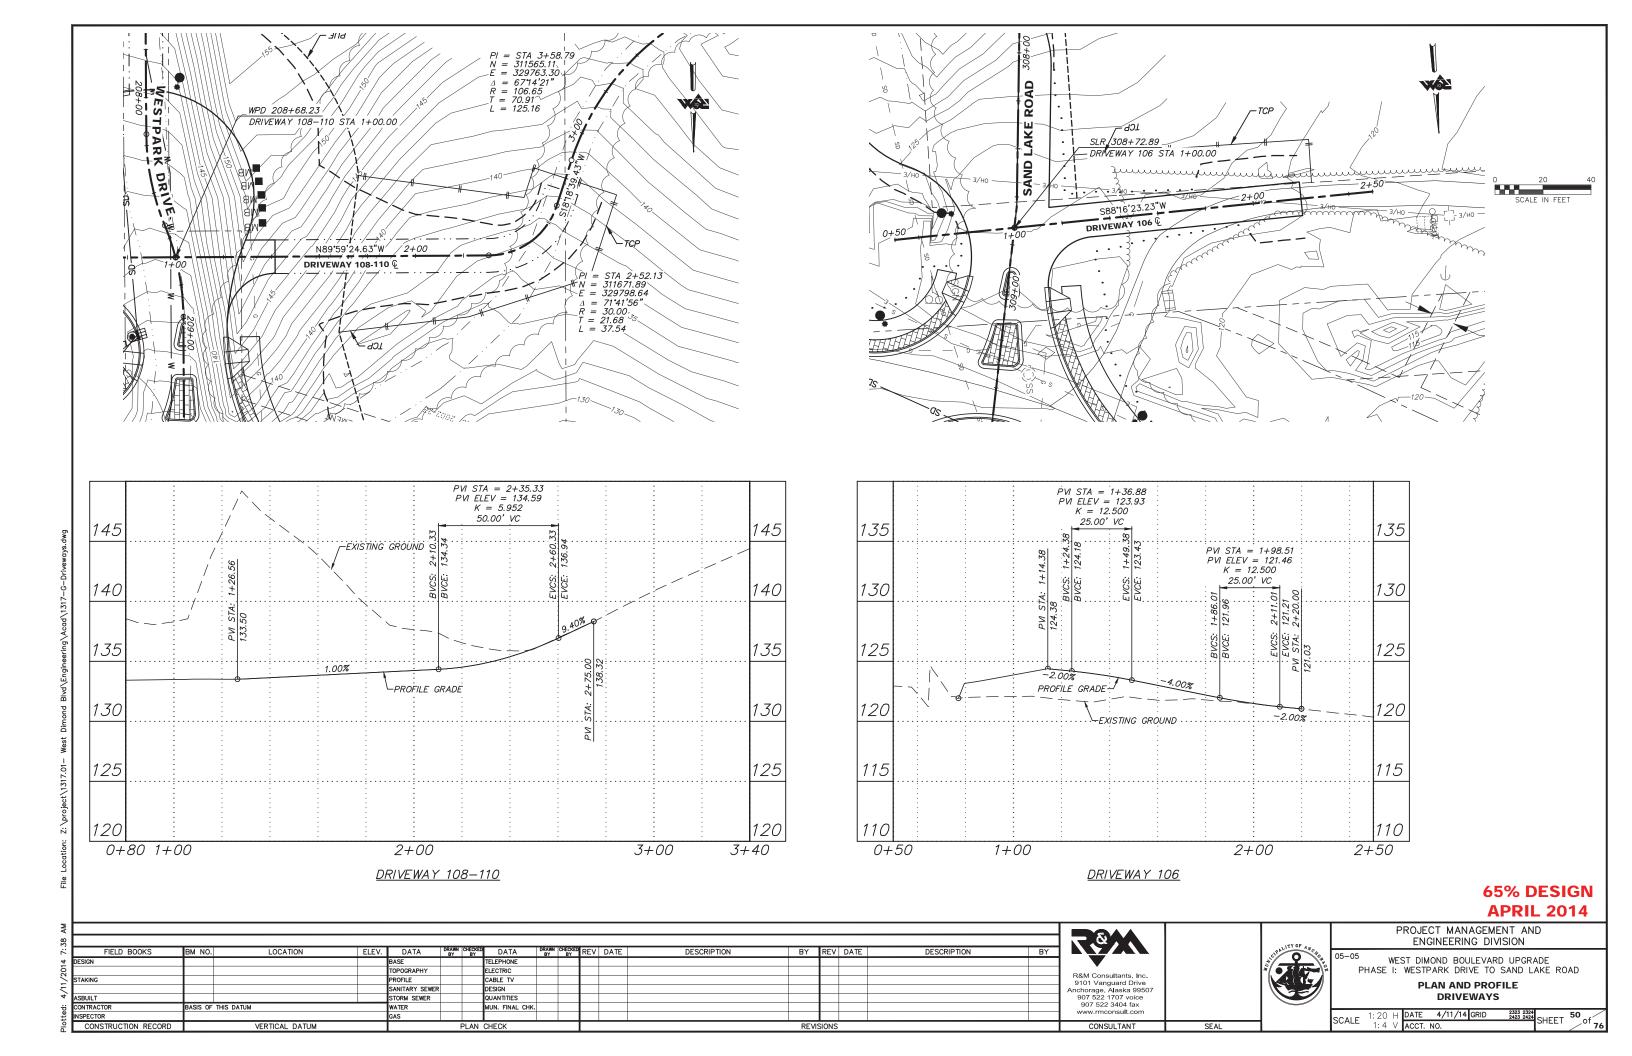
PROJECT MANAGEMENT AND ENGINEERING DIVISION


-05 WEST DIMOND BOULEVARD UPGRADE PHASE I: WESTPARK DRIVE TO SAND LAKE ROAD

# PLAN AND PROFILE DRIVEWAYS

SCALE	1:20	H DATE	4/11/14 GRID	2323 2324 2423 2424	CHEET	48 _ /
SCALE	1:4	√ ACCT	. NO.		SHEET	/ <sup>01</sup> 7





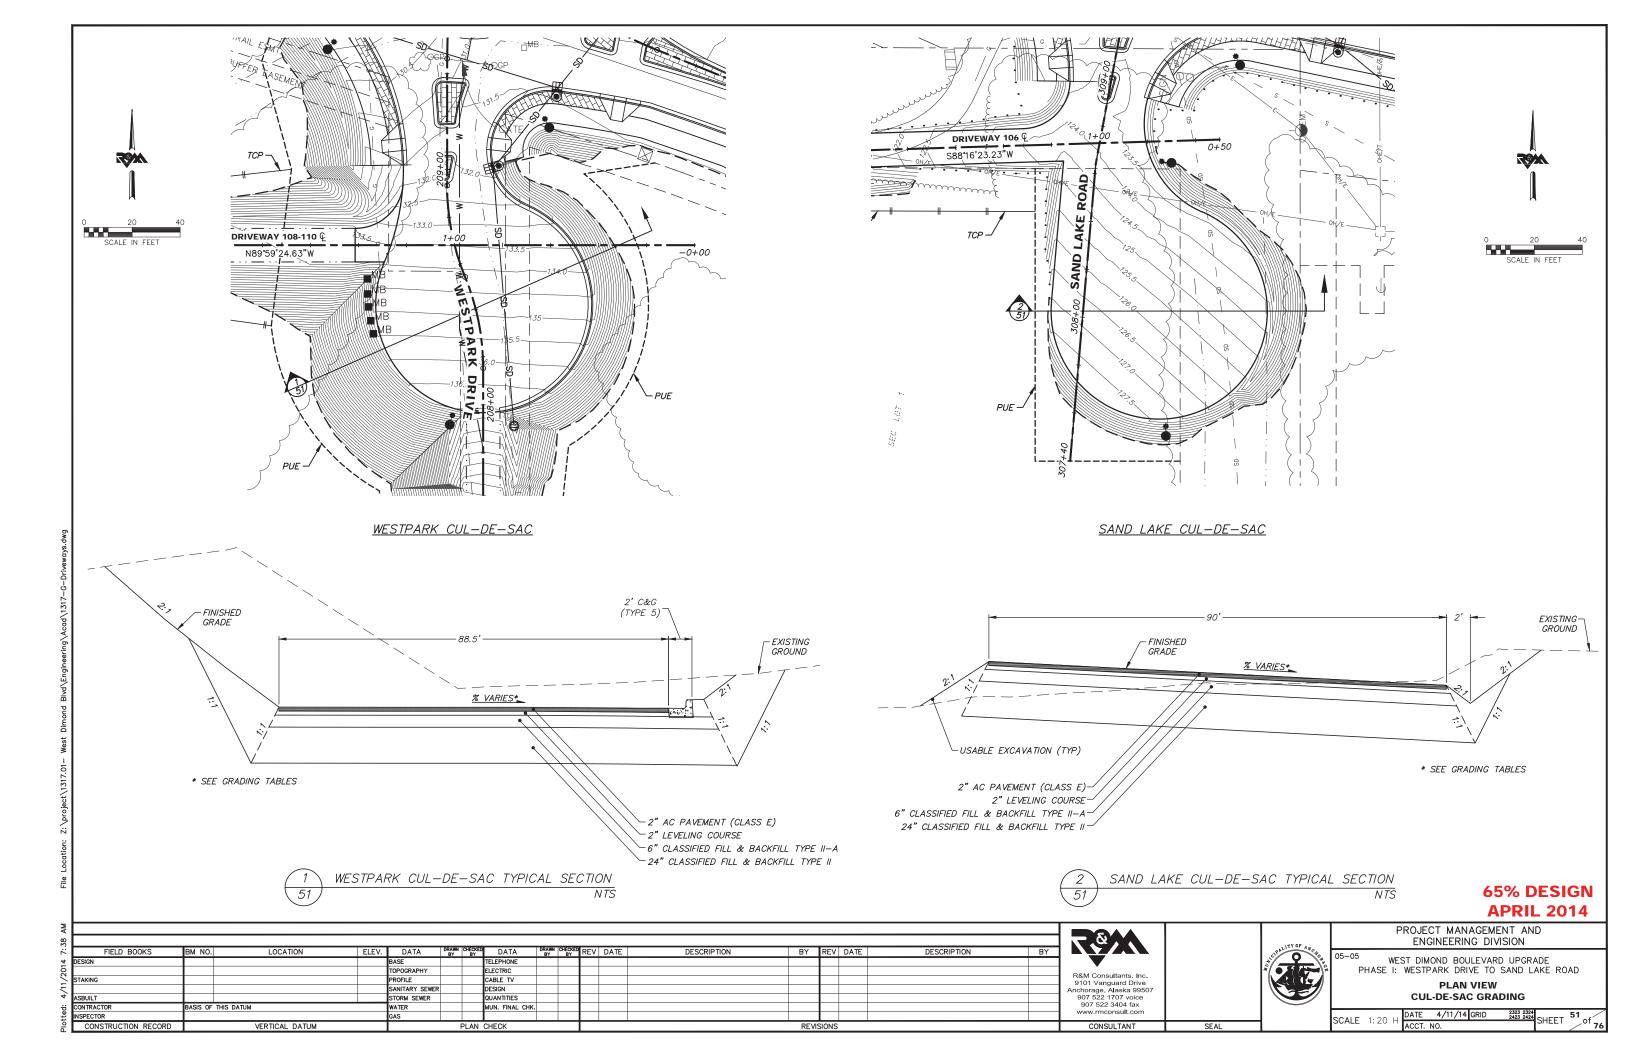

	SAND	LAKE CUL-E	E-SAC POINT	S
POINT	NORTHING	EASTING	ELEVATION	DESCRIPTION
RP1	9999.00	9999.00	150.00'	PC/PT/PI/MID/PCC/PRC
RP2	9999.00	9999.00	150.00'	PC/PT/PI/MID/PCC/PRC
RP3	9999.00	9999.00	150.00'	PC/PT/PI/MID/PCC/PRC
RP4	9999.00	9999.00	150.00	PC/PT/PI/MID/PCC/PRC
RP5	9999.00	9999.00	150.00	PC/PT/PI/MID/PCC/PRC
	<del>                                     </del>			
	<del>-</del>			

38																	<b>_</b>
7:	FIELD BOOKS	BM NO. LOCATION	ELEV.	DATA	DRAWN C	CHECKED By	DATA	DRAWN BY	CHECKED	REV	DATE	DESCRIPTION	BY	REV	DATE	DESCRIPTION BY	
4	DESIGN			BASE			TELEPHONE										
20				TOPOGRAPHY			ELECTRIC										
~	STAKING			PROFILE			CABLE TV										
Ė				SANITARY SEWER			DESIGN										Ar
4	ASBUILT			STORM SEWER			QUANTITIES										
÷	CONTRACTOR	BASIS OF THIS DATUM		WATER			MUN. FINAL CHK.										
ŧ	INSPECTOR			GAS													
9	CONSTRUCTION RECORD	VERTICAL DATUM			Р	LAN	CHECK						REV	SIONS	;		

R&M Consultants, Inc. 9101 Vanguard Drive Anchorage, Alaska 99507 907 522 1707 voice 907 522 3404 fax www.rmconsult.com

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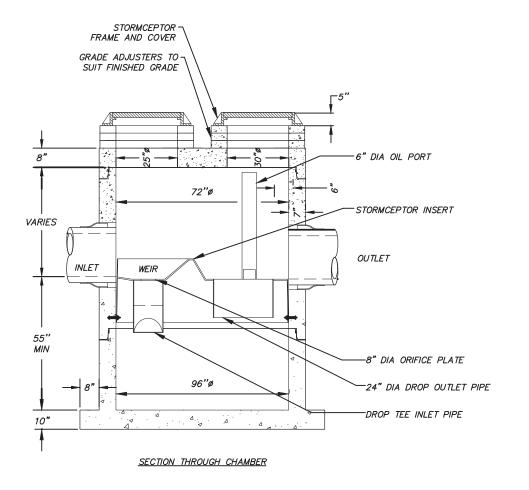


PROJECT MANAGEMENT AND ENGINEERING DIVISION


WEST DIMOND BOULEVARD UPGRADE
PHASE I: WESTPARK DRIVE TO SAND LAKE ROAD

**GRADING TABLES CUL-DE-SAC GRADING** 

DATE 4/11/14 GRID 2323 2324 SHEET 52 of 76 SCALE



STORMCEPTOR STC 900

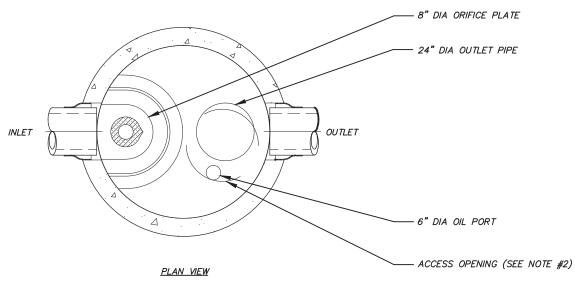


#### NOTES:


- 1. THE USE OF FLEXIBLE CONNECTION IS RECOMMENDED AT THE INLET AND OUTLET WHERE APPLICABLE.
- 2. THE USE OF FLEXIBLE CONNECTION IS RECOMMENDED AT THE INLET AND OUTLET WHERE AFFICABLE.

  2. THE 30"Ø OPENING WILL BE POSITIONED OVER THE OUTLET DROP PIPE AND THE OIL PORT. THE 25"Ø OPENING WILL BE POSITIONED OVER THE INLET DROP TEE.

  3. THE STORMCEPTOR SYSTEM IS PROTECTED BY ONE OR MORE OF THE FOLLOWING U.S. PATENTS: #4985148, #5498331, #5725760, #5753115, #5849181, #8068765, #6371690.

  4. CONTACT A CONCRETE PIPE DIVISION REPRESENTATIVE FOR FURTHER DETAILS NOT LISTED ON THIS DRAWING.
- 5. CONTRACTOR IS RESPONSIBLE TO MAKE ARRANGEMENTS WITH THE PRECASTER TO CAST THE "FILLET" PRIOR TO
- DELIVERY.
  6. DIMENSIONS MAY VARY WITH LOCAL MANUFACTURER, D&S CONCRETE INC., 2140 E. 84TH COURT, ANCHORAGE, AK

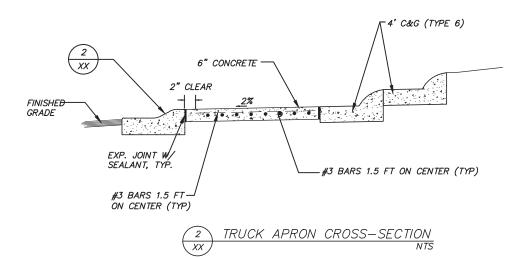

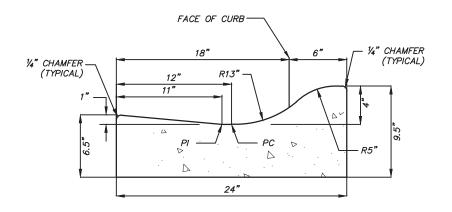

4" ROUNDABOUT TRUCK APRON CURB & GUTTER

#### **65% DESIGN APRIL 2014**


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38																7.0		ATY OF AL	
7:	FIELD BOOKS	BM NO. LOCATION	ELEV.	DATA	DRAWN CHECKED BY BY	DATA	DRAWN CHECK	REV	DATE	DESCRIPTION	BY	REV DAT	TE	DESCRIPTION	BY			CIPAL O CHO	05-05
4	DESIGN			BASE		TELEPHONE												\$\frac{1}{2} - \frac{1}{2} \right	WES
20				TOPOGRAPHY		ELECTRIC										R&M Consultants, Inc.			PHASE I: '
>	STAKING			PROFILE		CABLE TV										9101 Vanguard Drive			
_				SANITARY SEWER		DESIGN										Anchorage, Alaska 99507			
	ASBUILT			STORM SEWER		QUANTITIES										907 522 1707 voice			
		BASIS OF THIS DATUM		WATER		MUN. FINAL CHK.										907 522 3404 fax www.rmconsult.com			
tte	INSPECTOR			GAS												www.iinconsuit.com			SCALE
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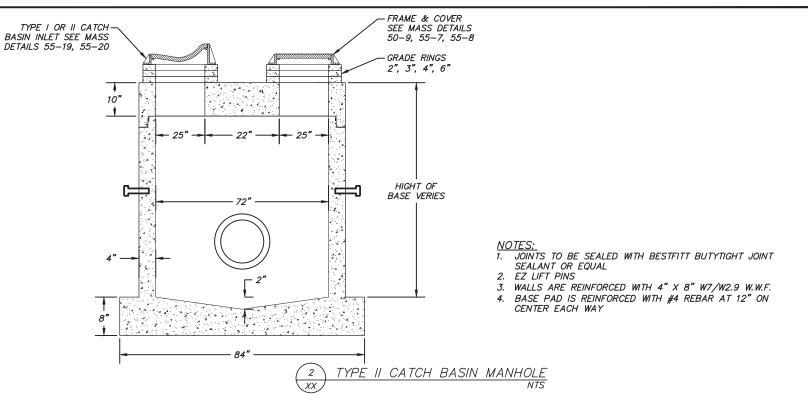
PROJECT MANAGEMENT AND ENGINEERING DIVISION


WEST DIMOND BOULEVARD UPGRADE I: WESTPARK DRIVE TO SAND LAKE ROAD


**DETAILS** 

2323 2324 2423 2424 SHEET 53 DATE 4/11/14 GRID



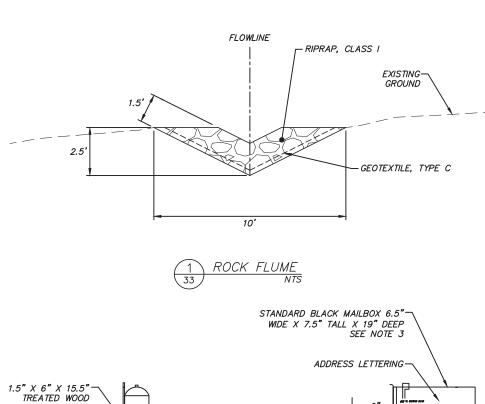

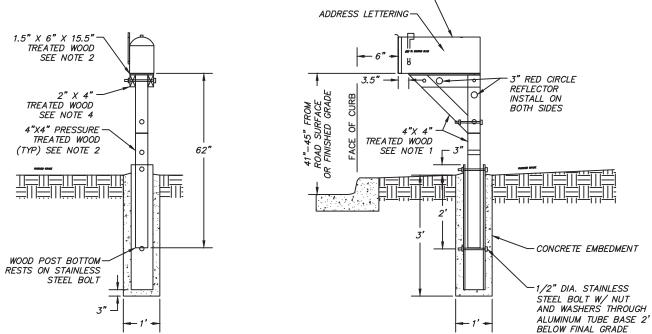

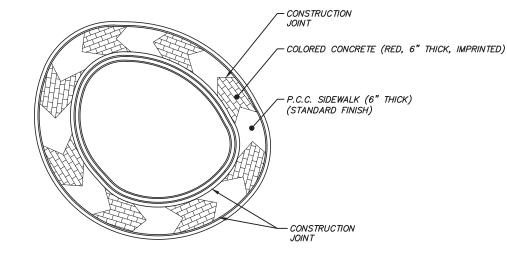

ROUNDABOUT CHEVRON CONCRETE PATTERN LAYOUT

NOTES:
1. CONTRACTOR SHALL FIELD VERIFY MAILBOX LOCATION AND PHYSICAL ADDRESS PRIOR TO ORDERING MATERIAL OR INSTALLATION.
2. ALL WOOD SHALL BE ALL WEATHER WOOD SEALED WITH A SEMI-TRANSPARENT OIL BASED STAIN BROWN IN COLOR. SUBMIT COLOR SAMPLE FOR APPROVAL.
3. CONTRACTOR SHALL COORDINATE WITH THE MOA AND ENGINEER IN THE FIELD REGARDING MAILBOX SUBSTITUTIONS OR MAILBOX SIZING, PRIOR TO ORDERING MATERIALS.

4. THE LOCATION OF EXISTING FEATURES AND UTILITIES SHOWN ARE APPROXIMATE. IT SHALL BE THE CONTRACTOR'S RESPONSIBILITY TO FIELD VERIFY THE HORIZONTAL AND VERTICAL LOCATION OF ALL ENCOUNTERED UTILITIES AND TO RECORD ANY CHANGES ON THE RECORD DRAWINGS.


5. CONTRACTOR SHALL INSTALL MAILBOX ADDRESS LABELS PER PLAN. ADDRESS LABELS SHALL BE A MINIMUM OF 1" IN HEIGHT AND INSTALLED ON THE WEST SIDE


OF THE MAILBOX VISIBLE FROM ON COMING TRAFFIC. ADDRESS LABELS SHOULD BE CENTERED BOTH VERTICAL AND HORIZONTAL ON MAILBOX.

6. CONTRACTOR SHALL POUR CONCRETE PATHWAY AROUND THE PROPOSED MAILBOX POST.
7. CUT-OFF EXCESS BOLT AND FILE SMOOTH, AFTER TIGHTENING

## 65% DESIGN **APRIL 2014**

PROJECT MANAGEMENT AND **78** ENGINEERING DIVISION FIELD BOOKS DESCRIPTION DESCRIPTION DATA REV DATE BY REV DATE WEST DIMOND BOULEVARD UPGRADE PHASE I: WESTPARK DRIVE TO SAND LAKE ROAD FCTRIC R&M Consultants, Inc. 9101 Vanguard Drive Anchorage, Alaska 99507 907 522 1707 voice CABLE TV **DETAILS** STORM SEWER UANTITIES 907 522 3404 fax ASIS OF THIS DATUM UN. FINAL CHK SHEET 54 www.rmconsult.com DATE 4/11/14 GRID SCALE

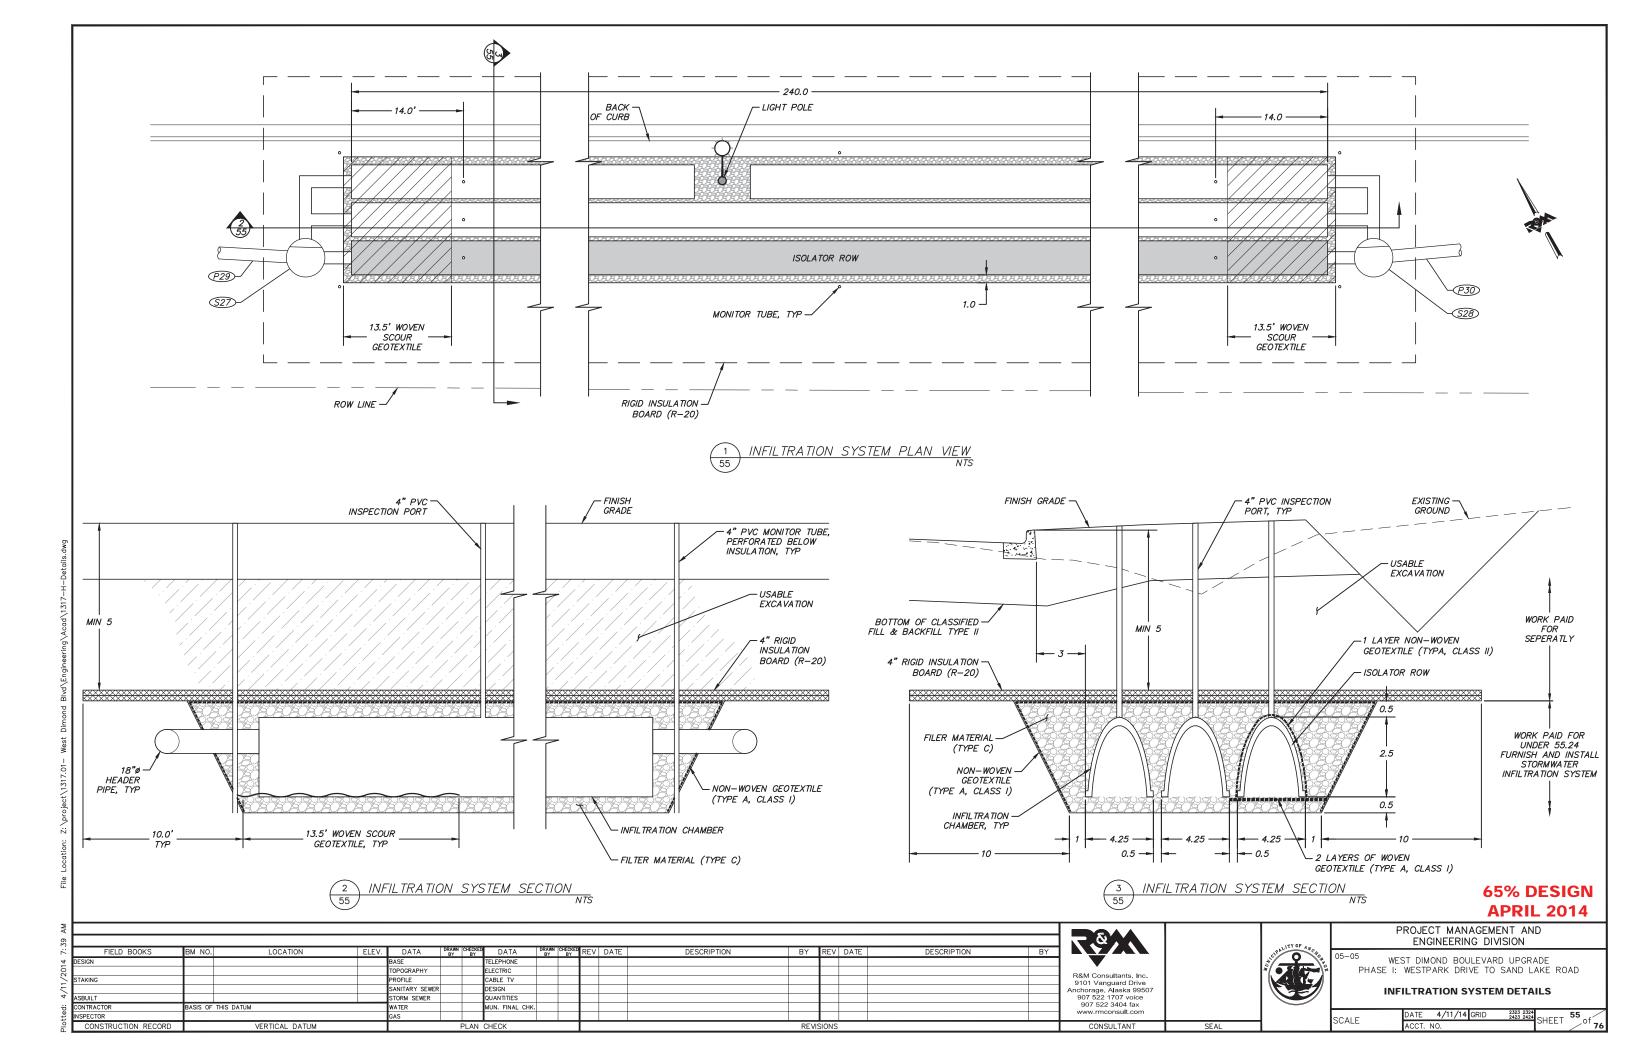

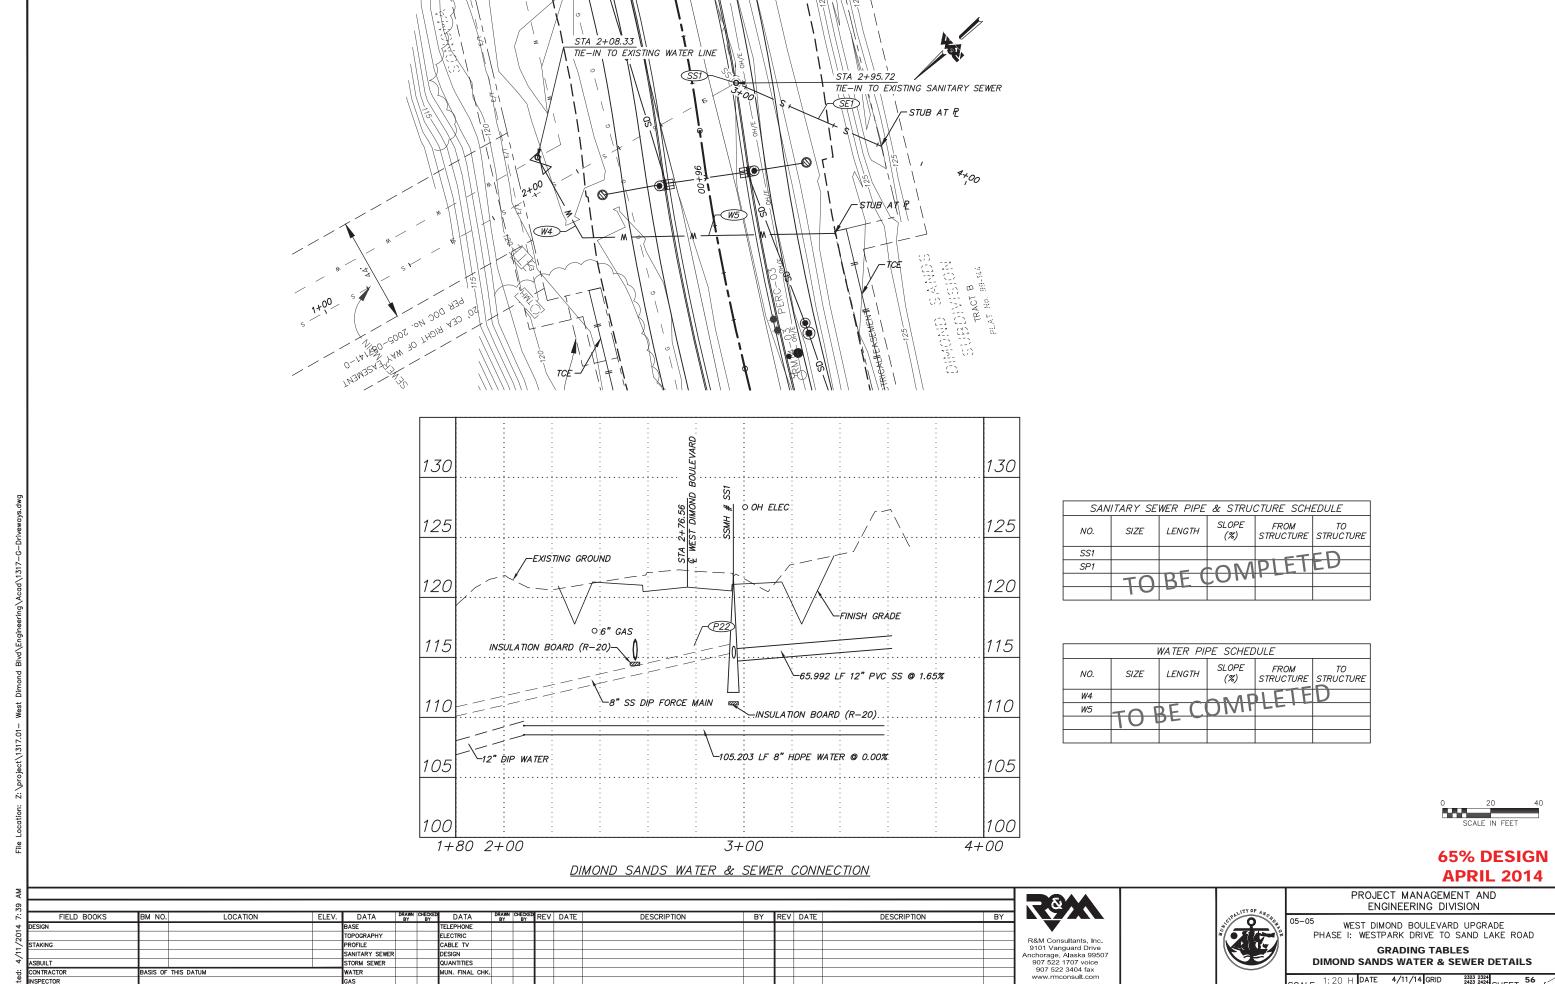

**GRADING TABLES** 

**DIMOND SANDS WATER & SEWER DETAILS** 

SCALE 1: 20 H DATE 4/11/14 GRID 2323 2324 SHEET 56 of 7.

CABLE TV

DESIGN QUANTITIES

MUN. FINAL CHK.

PROFILE

WATER

STORM SEWER

BASIS OF THIS DATUM

VERTICAL DATUM

TYPE 1A JUNCTION BOX

TYPE 2 JUNCTION BOX

 $\boxtimes$ LOAD CENTER

X/Y

CIRCUIT BREAKER

M

WATTHOUR METER

ELECTRICAL SITE PLAN

SCALE: 1" = 100'-0'

#### CIRCUIT AND DEVICE LEGEND

GROUP OR EQUIPMENT IDENTIFICATION. "A" DENOTES PANEL NAME "1" DENOTES CIRCUIT NUMBER

WR	ING SC	HEDULE
TAG	CONDUIT	WIRE
1	2 IN	1-3c#8
2	2 IN	2-3c#8
3	2 IN 2 IN	2-3c#8 1-3c#8

#### **ABBREVIATIONS**

- **AMPERE**
- AFF ABOVE FINISH FLOOR
- BCU BARE COPPER
- C CONDUIT
- CHUGACH ELECTRIC ASSOCIATION CEA
- CU COPPER
- (ALASKA) DEPARTMENT OF TRANSPORTATION DOT
- GROUND CONDUCTOR G
- HDPE HIGH DENSITY POLYETHYLENE CONDUIT
- KVA KILO-VOLT-AMPERES
- LED LIGHT-EMITTING DIODE
- LU LIGHTING UTILITY
- MOA MUNICIPALITY OF ANCHORAGE
- NEC NATIONAL ELECTRICAL CODE
- NFPA NATIONAL FIRE PROTECTION ASSOCIATION
- RMC(GALVANIZED) RIGID METAL CONDUIT
- TYP TYPICAL
- UON UNLESS OTHERWISE NOTED
- **VOLTS**
- W WATTS
- **WEATHERPROOF**

#### GENERAL ELECTRICAL NOTES

- 1. CALL BEFORE YOU DIG. HAVE ALL UTILITIES LOCATED PRIOR TO STARTING WORK. IMMEDIATELY NOTIFY THE ENGINEER IN THE EVENT OF CONFLICTS.
- 2. ELECTRICAL IMPROVEMENTS ARE NOT PERMITTED TO BE INSTALLED OUTSIDE OF THE RIGHT-OF-WAY OR WITHIN A UTILITY EASEMENT. IMMEDIATELY NOTIFY THE ENGINEER IN THE EVENT OF CONFLICTS.
- 3. COORDINATE LOAD CENTER INSTALLATIONS WITH CEA PRIOR TO INSTALLATION. INSTALLATIONS DEVIATING FROM THE PLANS SHALL BE APPROVED BY CEA AND THE ENGINEER PRIOR TO THE COMMENCEMENT OF WORK.
- 4. HDPE CONDUIT IS PERMITTED TO BE USED EXCEPT UNDER PAVED AREAS. INSTALL HDPE ACCORDING TO MASS 80.07 AND THE SPECIAL PROVISIONS. RMC SHALL BE INSTALLED UNDER ALL PAVED
- 5. COORDINATE WITH CEA FOR THE REMOVAL OF EXISTING ELECTROLIERS ON SOUTH SIDE OF WEST DIMOND. WORK TO BE PAID FOR BY OTHERS.
- 6. COORDINATE SALVAGE OF EXISTING ELECTROLIERS AND LOAD CENTER AT INTERSECTION OF WEST DIMOND AND SAND LAKE WITH
- DOT. WORK SHALL BE PAID FOR UNDER SECTION 80.28. 7. PROVIDE SCOTCH CAL 220 DECALS ON EXTERIOR OF NEW LOAD CENTER DENOTING OWNER (MOA) AND PURPOSE (LU).
- 8. PROVIDE ARC FLASH WARNING LABELS WITH INCIDENT ENERGY LEVEL VALUES AND PERSONNEL PROTECTIVE EQUIPMENT (PPE)
  REQUIREMENTS ON EACH PIECE OF EQUIPMENT IN ACCORDANCE WITH NEC ARTICLE 110.16 AND NFPA 70E.
- 9. PROVIDE LABELS INDICATING MAXIMUM AVAILABLE FAULT CURRENT ON EACH PIECE OF SERVICE EQUIPMENT IN ACCORDANCE WITH NEC ARTICLE 110.24.
- 10. DELIVER THE FOLLOWING ADDITIONAL EQUIPMENT TO MOA STREET LIGHT MAINTENANCE (343-8242):
  - 5EA 27FT LUMINAIRE POLES
- 5EA 12FT LUMINAIRE POLE ARMS
- 5EA 60-LED LUMINAIRES

CERTIFY THAT THE NEW ROADWAY ILLUMINATION LAYOUTS MEET THE REQUIREMENTS OF CHAPTER 5 OF THE DESIGN CRITERIA MANUAL USING THE LUMINANCE METHOD SHOWN ON TABLE 5-2. I CERTIFY THAT THE NEW INTERSECTION LAYOUTS MEET THE ILLUMINATION REQUIREMENTS OF CHAPTER 5 OF THE DESIGN CRITERIA MANUAL USING THE ILLUMINANCE METHOD SHOWN ON TABLE 5-5.

(RNP SIGNATURE)

WEST DIMOND BLVD

65% DESIGN **APRIL 2014** 

FIELD BOOKS LOCATION DATA DESCRIPTION BY REV DATE DESCRIPTION BM NO. ELEV. DATA ECKED REV DATE POGRAPH ECTRIC UANTITIES ORM SEWER UN. FINAL CHK VERTICAL DATUM REVISIONS

EDC, Inc. 213 W. FIREWEED LANE

(907) 276-7933

ANCHORAGE, AK 99503




PROJECT MANAGEMENT AND ENGINEERING DIVISION

<sup>15</sup> WEST DIMOND BOULEVARD UPGRADE PHASE I: WESTPARK DRIVE TO SAND LAKE ROAD

ELECTRICAL LEGEND, ABBREVIATIONS, AND SITE PLAN

4/3/14 GRID 2323 2324 2423 2424 SHEET

100'

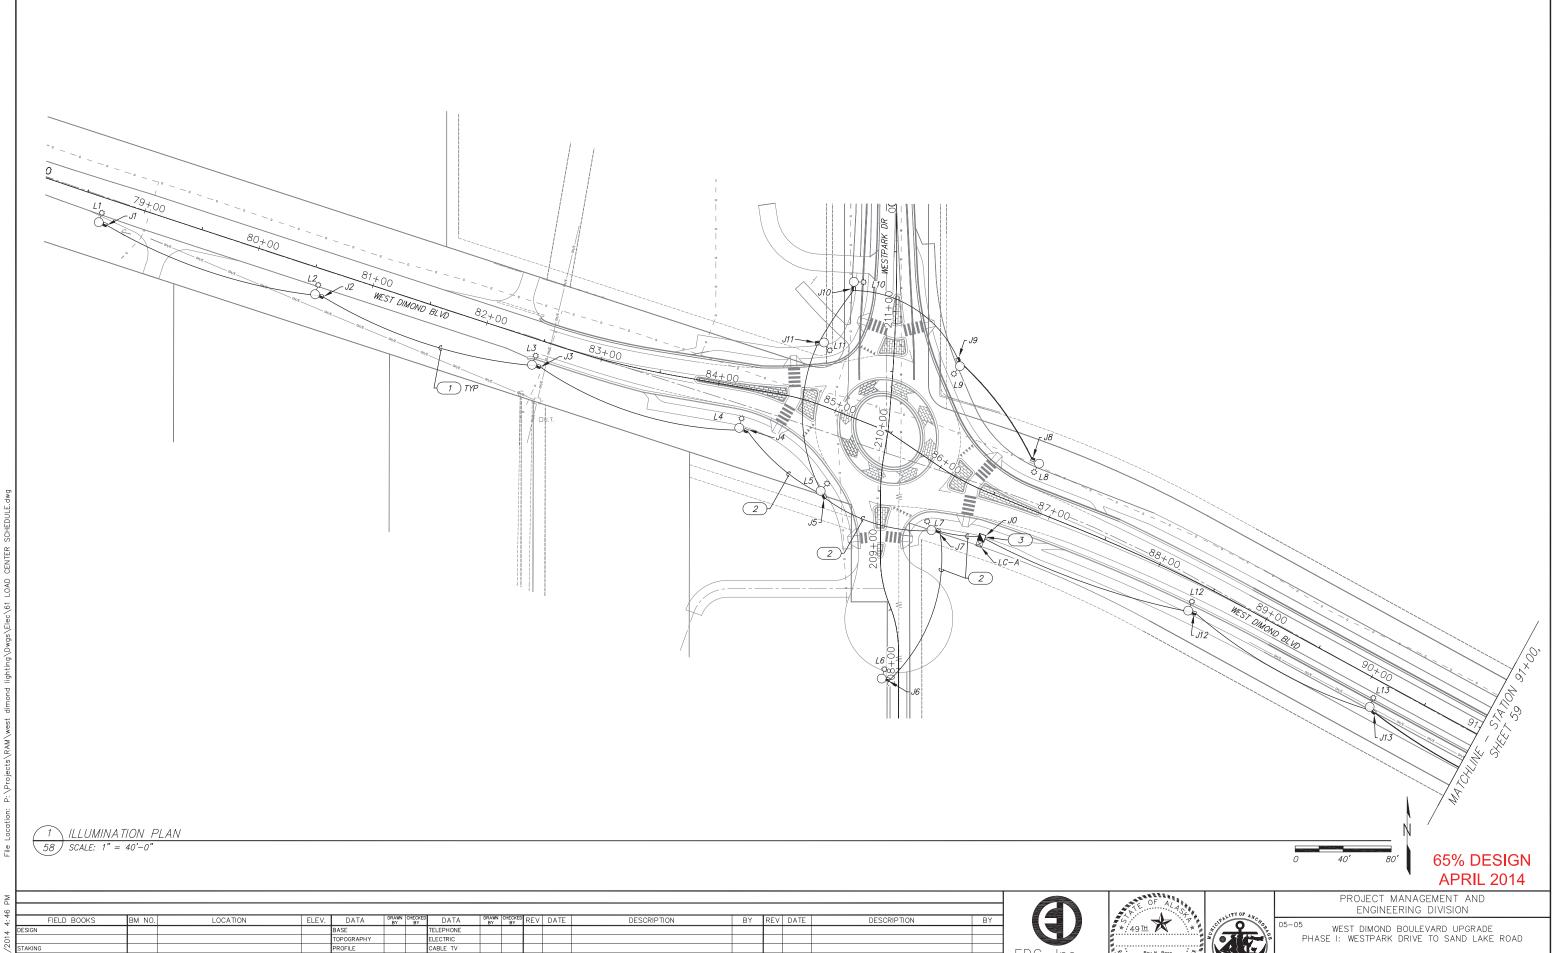


ELECTRIC CABLE TV PROFILE SANITARY SEWER STORM SEWER WATER DESIGN QUANTITIES BASIS OF THIS DATUM MUN. FINAL CHK. VERTICAL DATUM REVISIONS

EDC, Inc. 213 W. FIREWEED LANE ANCHORAGE, AK 99503 (907) 276-7933 CONSULTANT

Roy N. Po... EE 12053 PROFESSIONN

ILLUMINATION PLAN

DATE 4/3/14 GRID 2323 2324 ACCT. NO. SHEET SCALE

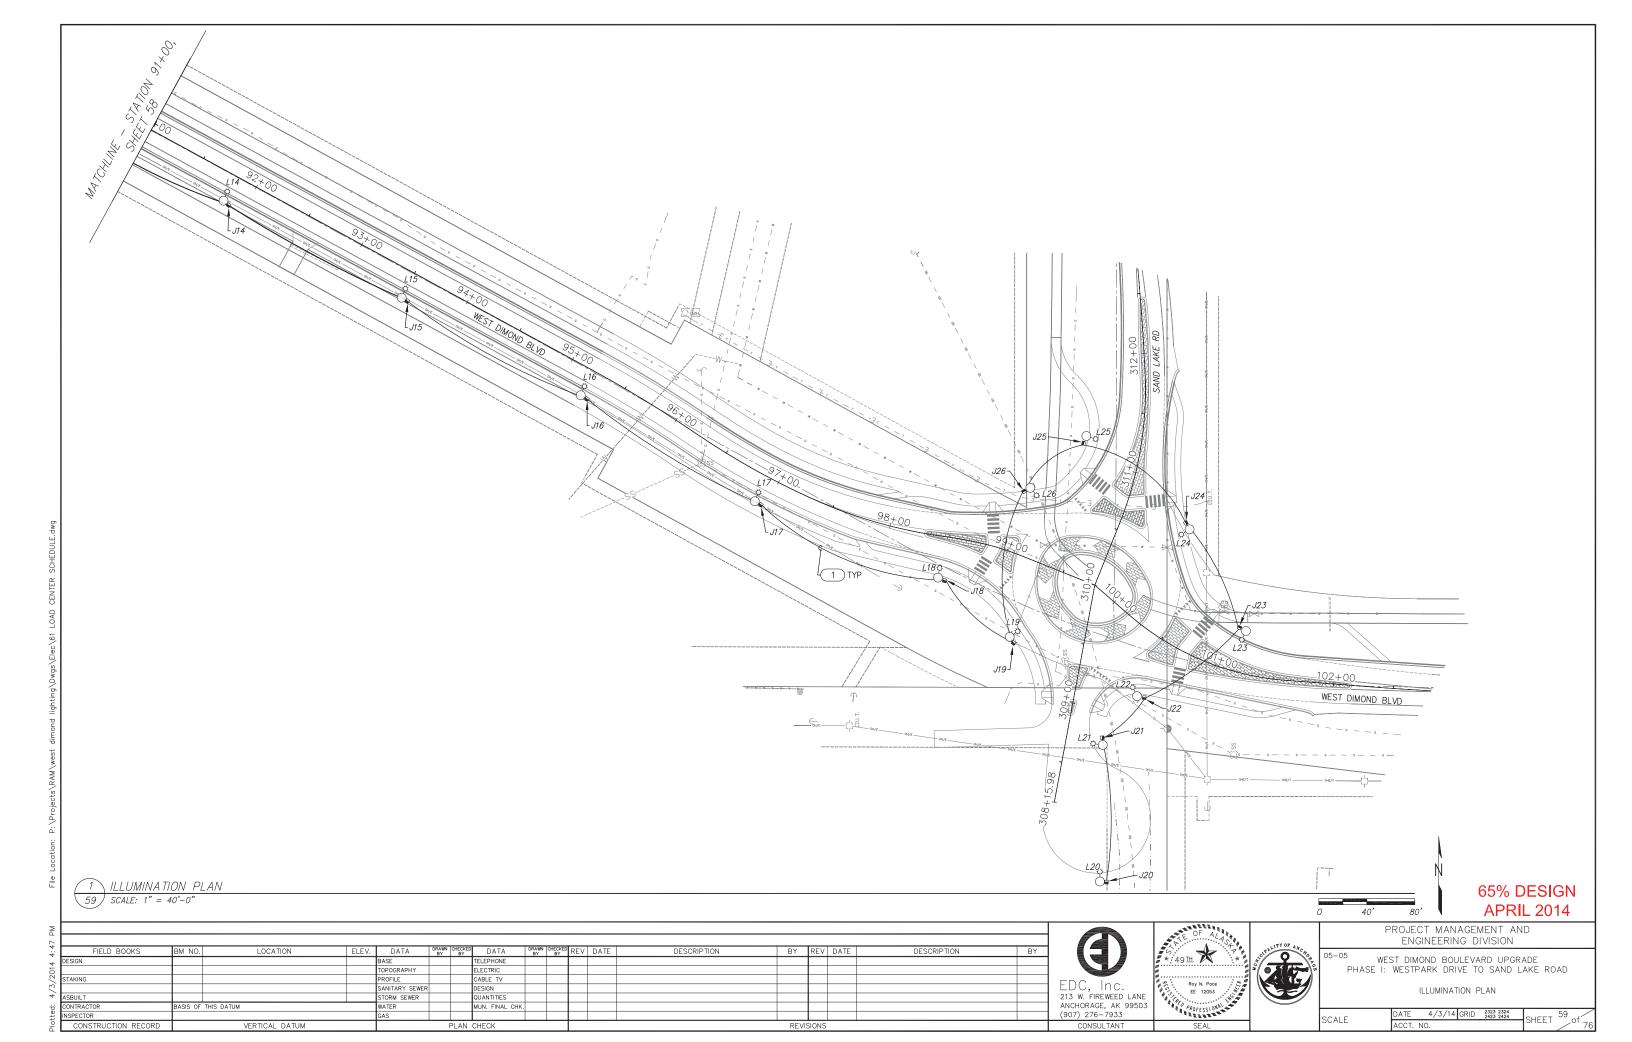

L6			134W	480V	27FT	12.0	M-C-3
L7			229W	480V	27FT	12.0	M-C-3
L8			229W	480V	27FT	12.0	M-C-3
L9			229W	480V	27FT	12.0	M-C-3
L10			229W	480V	27FT	12.0	M-C-3
L11			229W	480V	27FT	12.0	M-C-3
L12			134W	480V	27FT	12.0	M-C-3
L13			134W	480V	27FT	12.0	M-C-3
L14			134W	480V	27FT	12.0	M-C-3
L15			134W	480V	27FT	12.0	M-C-3
L16			134W	480V	27FT	12.0	M-C-3
L17			134W	480V	27FT	12.0	M-C-3
L18			274W	480V	27FT	12.0	M-C-3
L19			274W	480V	27FT	12.0	M-C-3
L20			183W	480V	27FT	12.0	M-C-3
L21			274W	480V	27FT	12.0	M-C-3
L22			274W	480V	27FT	12.0	M-C-3
L23			274W	480V	30FT	-	M-C-3
L24			274W	480V	27FT	12.0	M-C-3
25			274W	480V	27FT	12.0	M-C-3
L26			274W	480V	27FT	12.0	M-C-3
TA TIONING	S IS APPROXIMATE,	POSITION SH	HOULD E	E VERIF	IED BY FIE	LD ENGINE	ER.
AST ARM	SHALL BE PERPEN	DICULAR TO	ROADW	AY CENT	TERLINE UN	LESS OTH	ERWISE NOTED.
	LOAD	CENTER	R SCH	HEDUL.	E		
LC#	STATIONING	OFFSE T	r	TYPE	VOL TAGE	SHEET	NO.
				1A	480/240V		
Α	l G IS APPROXIMATE,						

STATIONING

POLE

L2

L3

L4

L5

OFFSET

WATTS VOLTS

134W

134W

229W

480V

480V

480V

480V

229W 480V

ELECTROLIER SCHEDULE

HEIGHT

27FT

27FT

27FT

27FT

27FT

ARM

LENGTH

12.0

12.0

12.0

12.0

12.0

LIGHTING

DISTRIBUTION

M - C - 3

M - C - 3

M-C-3

M - C - 3

BASE TYPE

FIXED

SHEET NO.

58

58

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59

59

59

59 45° POLE

CIRCUIT

A - 5, 7

A-5,7

A - 5, 7

A - 6.8

A-6,8

A-6,8

A-6,8

A-6,8

A-6,8

A-6,8

A-6,8

A - 2, 4

A-2,4

A-2,4

A - 2, 4

A - 2, 4

A-2,4

A-2,4

NOTES

JU	INCTION BOX	<i>SCHEDULE</i>	
J-BOX#	STATIONING	OFFSET	TYPE
JO			2
J1			1A
J2			1A
J3			1A
J4			1A
J5			1A
J6			1A
J7			1A
J8			1A
J9			1A
J10			1A
J11			1A
J12			1A
J13			1A
J14			1A
J15			1A
J16			1A
J17			1A
J18			1A
J19			1A
J20			1A
J21			1A
J22			1A
J23			1A
STATIONING	G IS APPROXIMAT VERIFIED BY FIE		ULD BE


INTERSECTION ILLUMINANCE — WEST DIMOND BLVD										
CROSS STREET	A VERAGE ILLUMINANCE	UNIFORMITY (AVE/MIN)	IESNA INTERSECTION TYPE	PEDESTRIAN CONFLICT						
SAND LAKE	2.61	2.80:1	MAJOR/MAJOR	MEDIUM						
WESTPARK	2.25	2.41:1	MAJOR/COLLECTOR	MEDIUM						


LUMINAIRE PERFORMANCE								
CRITERI	'A							
POLE TYPE	MAST ARM							
LAMP	LED							
LED COUNT	60							
LIGHT LOSS FACTOR	0.80							
AIMING ANGLE	0							
NUMBER OF LANES	2							
ROAD WIDTH	22 FT							
MEDIAN WIDTH	0 FT							
MOUNTING HEIGHT	30 FT							
ARM LENGTH	12 FT							
SETBACK	12 FT							
SPACING	170 FT							
AVERAGE LUMINANCE	0.53 CD/M²							
UNIFORMITY (AVE/MIN)	1.77:1							
UNIFORMITY (MAX/MIN)	3.67:1							
VEILING LUMINANCE	0.27							

LUMINAIRE	SCHEDULE				
MANUFACTURER	BETALED OR APPROVED EQUAL				
MODEL	LEDWAY, GENERATION E				
LIGHT SOURCE	LED				
WA TTA GE	134W				
LED COUNT	60				
COLOR TEMP	4,000K				
MINIMUM CRI	70				
INITIAL OUTPUT	10,666 LUM				
DRIVE CURRRENT	700MA				
VOL TAGE	480V				
PHOTOCELL	NO				
LENS TYPE	CUT OFF				
IES DISTRIBUTION	M-C-3				
UL LISTED	YES				
SHIELDED	YES				
WARRANTY	10 YEARS				
LUMINAIRE	SCHEDULE				
MANUFACTURER	BETALED OR APPROVED EQUAL				
MODEL	LEDWAY, GENERATION E				
LIGHT SOURCE	LED				
WATTAGE	229W				

LOMINAINL	JUITEDULL
MANUFACTURER	BETALED OR APPROVED EQUA
MODEL	LEDWAY, GENERATION E
LIGHT SOURCE	LED
WATTAGE	229W
LED COUNT	100
COLOR TEMP	4,000K
MINIMUM CRI	70
INITIAL OUTPUT	17,769 LUM
DRIVE CURRRENT	700MA
<i>VOLTAGE</i>	480V
PHOTOCELL	NO
LENS TYPE	CUT OFF
IES DISTRIBUTION	M-C-3
UL LISTED	YES
SHIELDED	NO
WARRANTY	10 YEARS

LUMINAIRE	SCHEDULE
MANUFACTURER	BETALED OR APPROVED EQUAL
MODEL	LEDWAY, GENERATION E
LIGHT SOURCE	LED
WA TTA GE	274W
LED COUNT	120
COLOR TEMP	4,000K
MINIMUM CRI	70
INITIAL OUTPUT	21,190 LUM
DRIVE CURRRENT	700MA
VOL TAGE	480V
PHOTOCELL	NO
LENS TYPE	CUT OFF
IES DISTRIBUTION	M-C-3
UL LISTED	YES
SHIELDED	NO
WARRANTY	10 YEARS

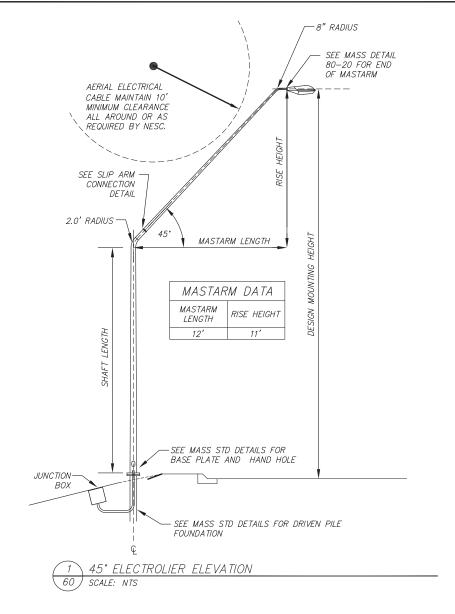


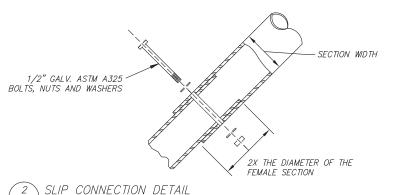

65% DESIGN **APRIL 2014** 

a,																		
Ω																		1
	FIELD BOOKS	BM NO.	LOCATION	ELEV.	DATA	DRAWN BY	CHECKED BY	DATA	DRAWN BY	CHECKED BY	REV	DATE	DESCRIPTION	BY	REV DATE	DESCRIPTION	BY	
4	DESIGN				BASE			TELEPHONE										1
5					TOPOGRAPHY			ELECTRIC										1
	STAKING				PROFILE			CABLE TV										1
_					SANITARY SEWER			DESIGN										1
4	ASBUILT				STORM SEWER			QUANTITIES										1
ö	CONTRACTOR	BASIS OF	THIS DATUM		WATER			MUN. FINAL CHK.										1
£	INSPECTOR				GAS													L
0	CONSTRUCTION RECORD VERTICAL DATUM				PLAN CHECK					REVISIONS							Γ	



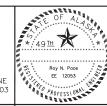

60 SCALE: NTS




PROJECT MANAGEMENT AND ENGINEERING DIVISION

<sup>05</sup> WEST DIMOND BOULEVARD UPGRADE PHASE I: WESTPARK DRIVE TO SAND LAKE ROAD

LIGHTING SCHEDULES

DATE 4/11/14 GRID 2323 2324 SHEET SCALE

	SUMMARY OF LOAD CENTER LC-A											
LOAD CENTER TYPE: 1A												
	ING UT		CEA									
SERV	ICE CO	NDUIT TYPE:	RIGID	META	L COI	VDUIT						
			LO	CATIC	N DA	1 <i>TA</i>						
LOAD	CENTE	:R:	SEE S	SHEET	60 F	OR ST	A TIONING					
POWE	R SOU	RCE:	NEW	LINE I	XTEN	SION						
PH01	OELEC:	TRIC CONTROL:		DAD C								
SERV	ICE VO	LTAGE			3 WIRE	, 480,	/240 VOLTS AC WITH (	GROUNI	DED			
PROV	IDF MF	TER SOCKET?	YES	NEUTRAL (FS								
	BREAK											
	ACTOR.			600V, 12-POLE								
				PAN	EL A							
POLE	AMP TRIP	DESCRIPTION	POLE KVA	Aø	Bø	POLE KVA	DESCRIPTION	AMP TRIP	POLE			
1	15/2	PHOTOCFI I	0.1	1.3		1.2	LIGHTING, WEST	20/2	2			
3	13/2	PHOTOGELL	0.0		1.2	1.2	DIMOND EAST*	20/2	4			
5	20/2	LIGHTING, WEST	0.2	0.8		0.6	LIGHTING, WESTPARK	20/2	6			
7	20/2	DIMOND WEST*	0.2		0.8	0.6	ROUNDABOUT*	20/2	8			
9			0.0	0.0		0.0			10			
11			0.0		0.0	0.0			12			
13			0.0	0.0		0.0			14			
*	CIRCUI	T THROUGH CONTACT	OR	2.1	2.0		TOTA	L KVA				
	21007							<u>AMPS</u>	8.5			

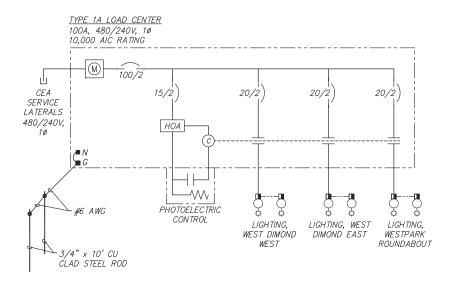


1 LOAD CENTER "A" POWER ONE-LINE
61 SCALE: NTS

VC	VOLTAGE DROP CALCULATION — LC—A										
POWER-FA	480V AC IN A 1—PH, 3 WIRE CONFIGURATION WITH A POWER—FACTOR OF 0.8, 1 COPPER CONDUCTOR PER PHASE IN A RMC. TEMPERATURE RATING 75°C.										
CKT #	SEGMENT SIZE (AWG)	SEGMENT LENGTH (FT)	LOAD (KVA)	TOTAL (AMPS)	SEG. (%VD)						
<i>5,7</i>	#8	800	2.30	4.79	2.65						
2,4	#8	560	2.40	5.00	2.72						
6,8	#8	560	0.58	1.21	0.19						

SHORT CIRCUIT	SHORT CIRCUIT CALCULATION — LC—A										
480V AC IN A 1-PH, 3 WIRE CONFIGURATION, 1 COPPER CONDUCTOR PER PHASE IN A											
RMC. TEMPERATURE RATING 75°C.											
ANTICIPATED TRANSFORMER RATING	50KVA										
VOLTAGE	480/240V										
TRANSFORMER IMPEDANCE	1.2%										
LET-THRU SHORT CIRCUIT CURRENT	8,681A										
LENGTH TO FAULT	40FT										
SERVICE CONDUCTOR SIZE	1/0 AL										
CONDUIT	NON-MAGNETIC										
"C" CONSTANT	5,838										
LINE-LINE FAULT	6,957A										
LINE-NEUTRAL FAULT	7,468A										

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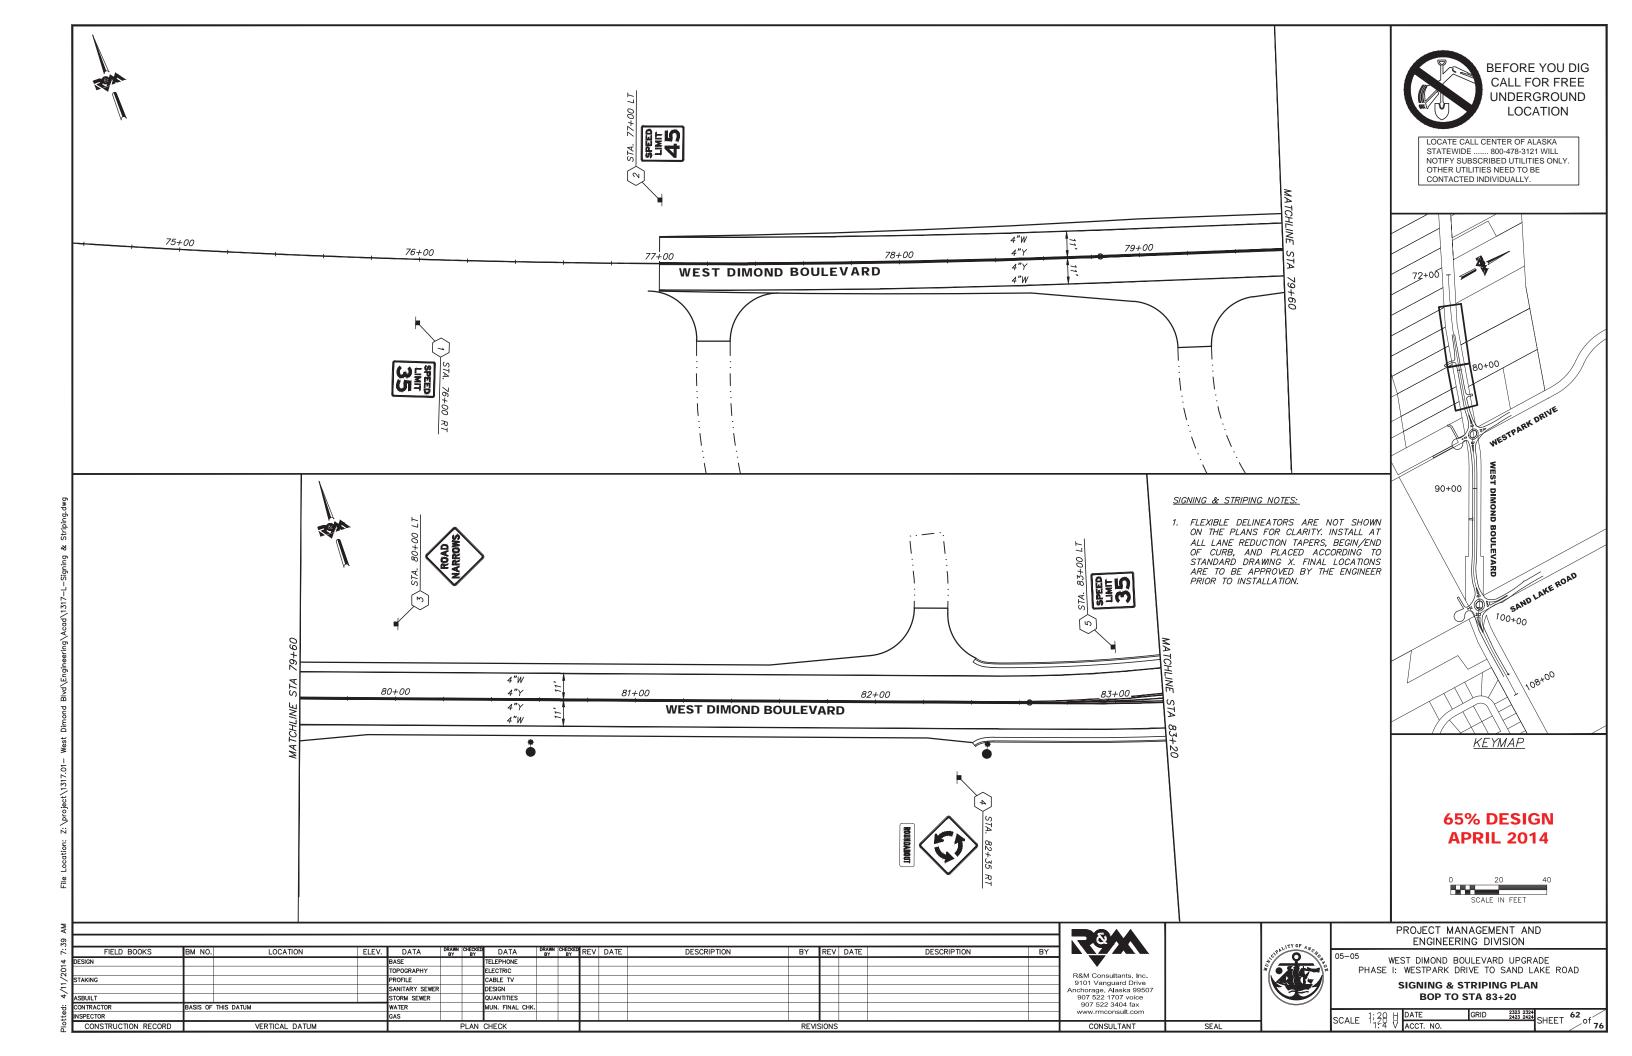


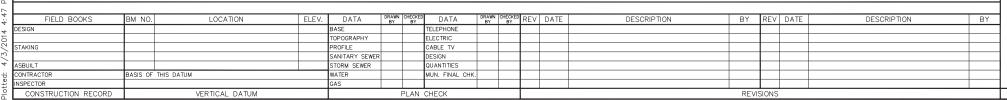
PROJECT MANAGEMENT AND ENGINEERING DIVISION


WEST DIMOND BOULEVARD UPGRADE
PHASE I: WESTPARK DRIVE TO SAND LAKE ROAD


LOAD CENTER SCHEDULE


CALE	DATE	4/3/14	GRID	2323 2324 2423 2424	CHEET	61	/
CALL	ACCT. NO	).			SHEET	01	76




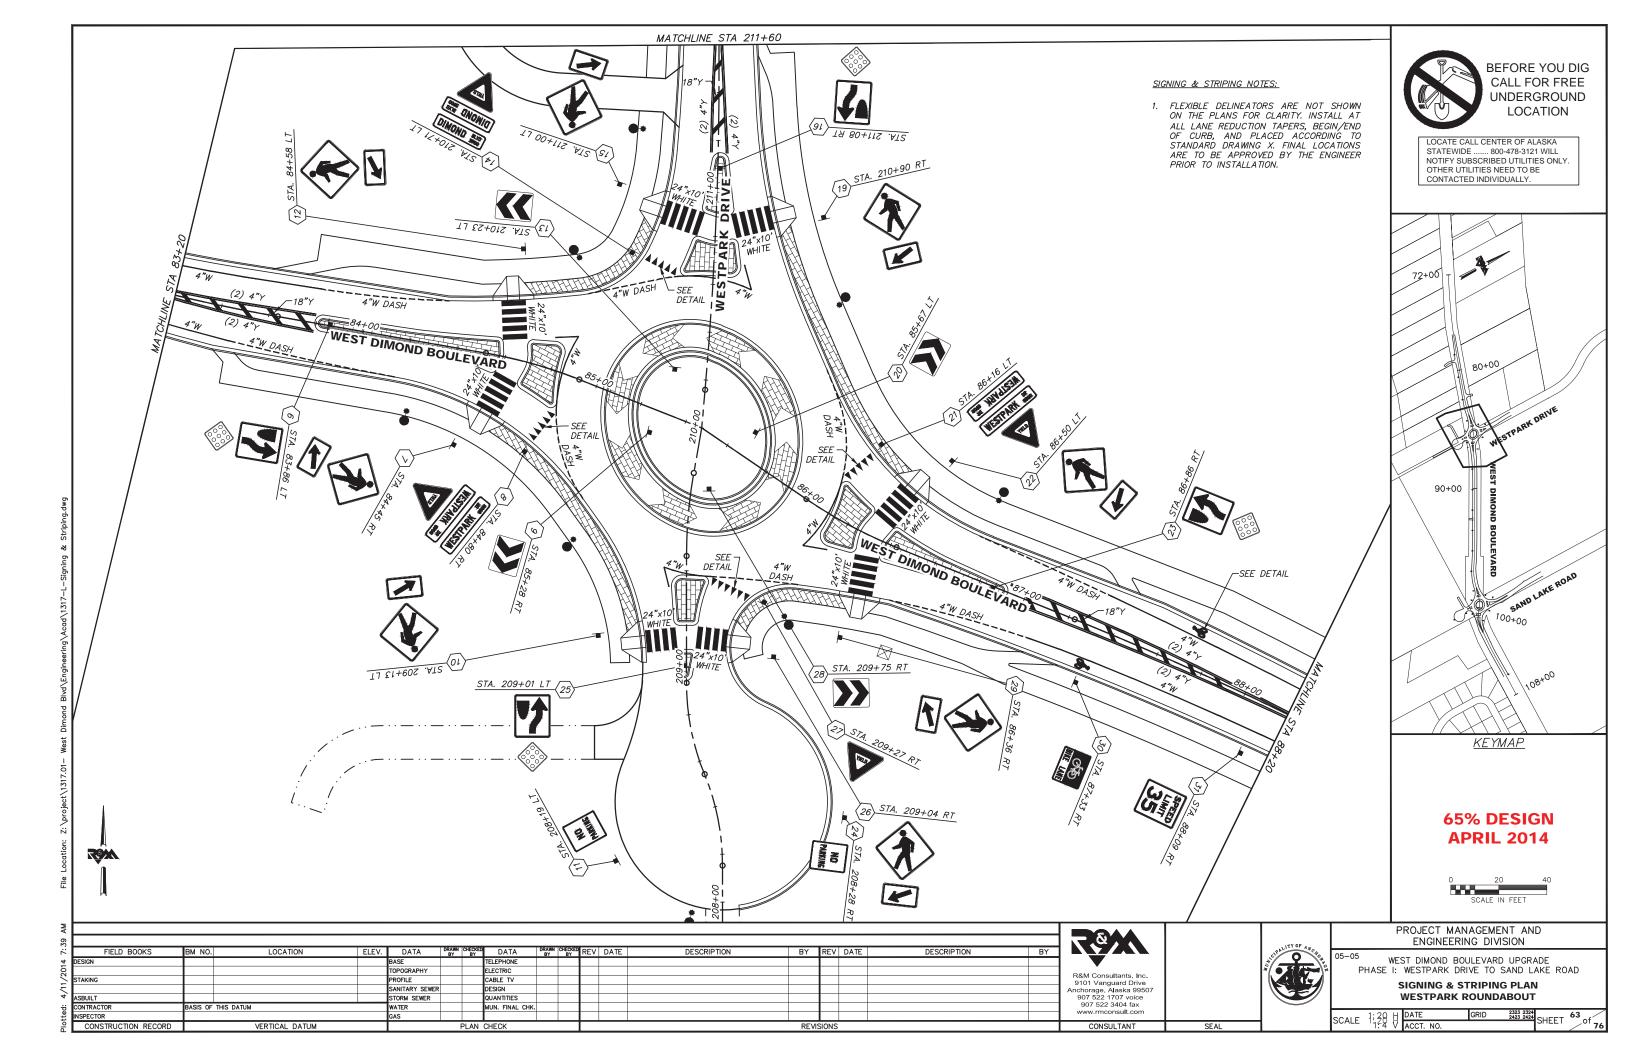

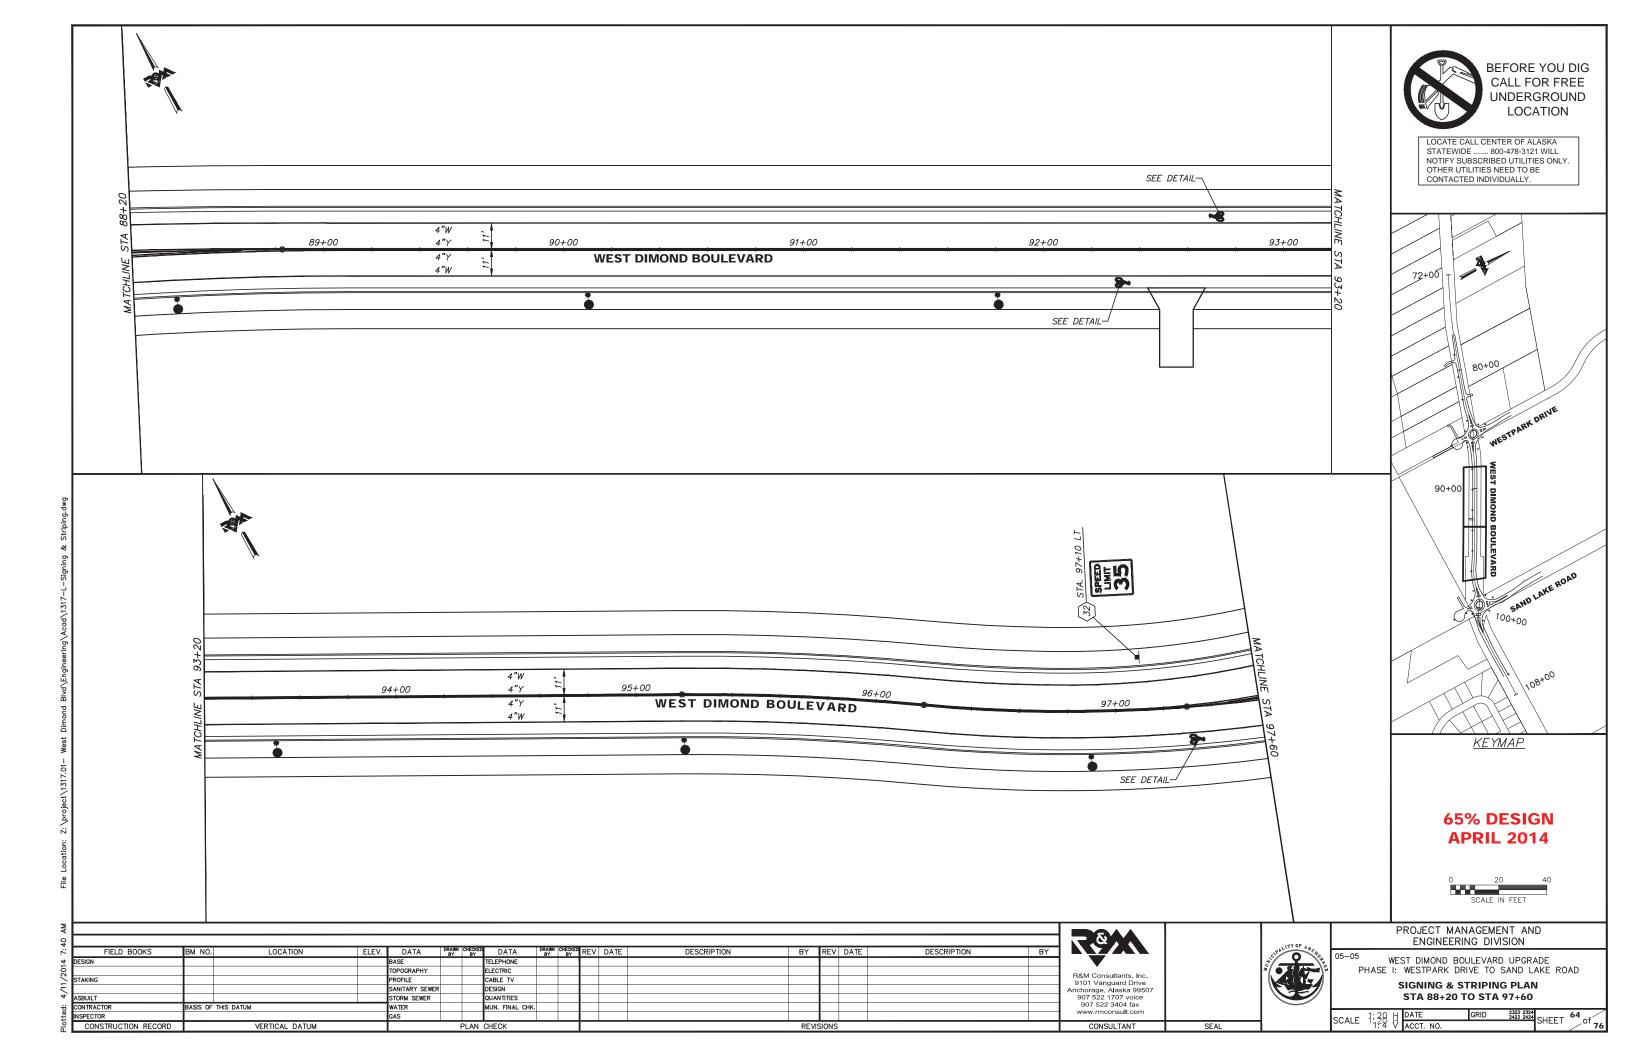

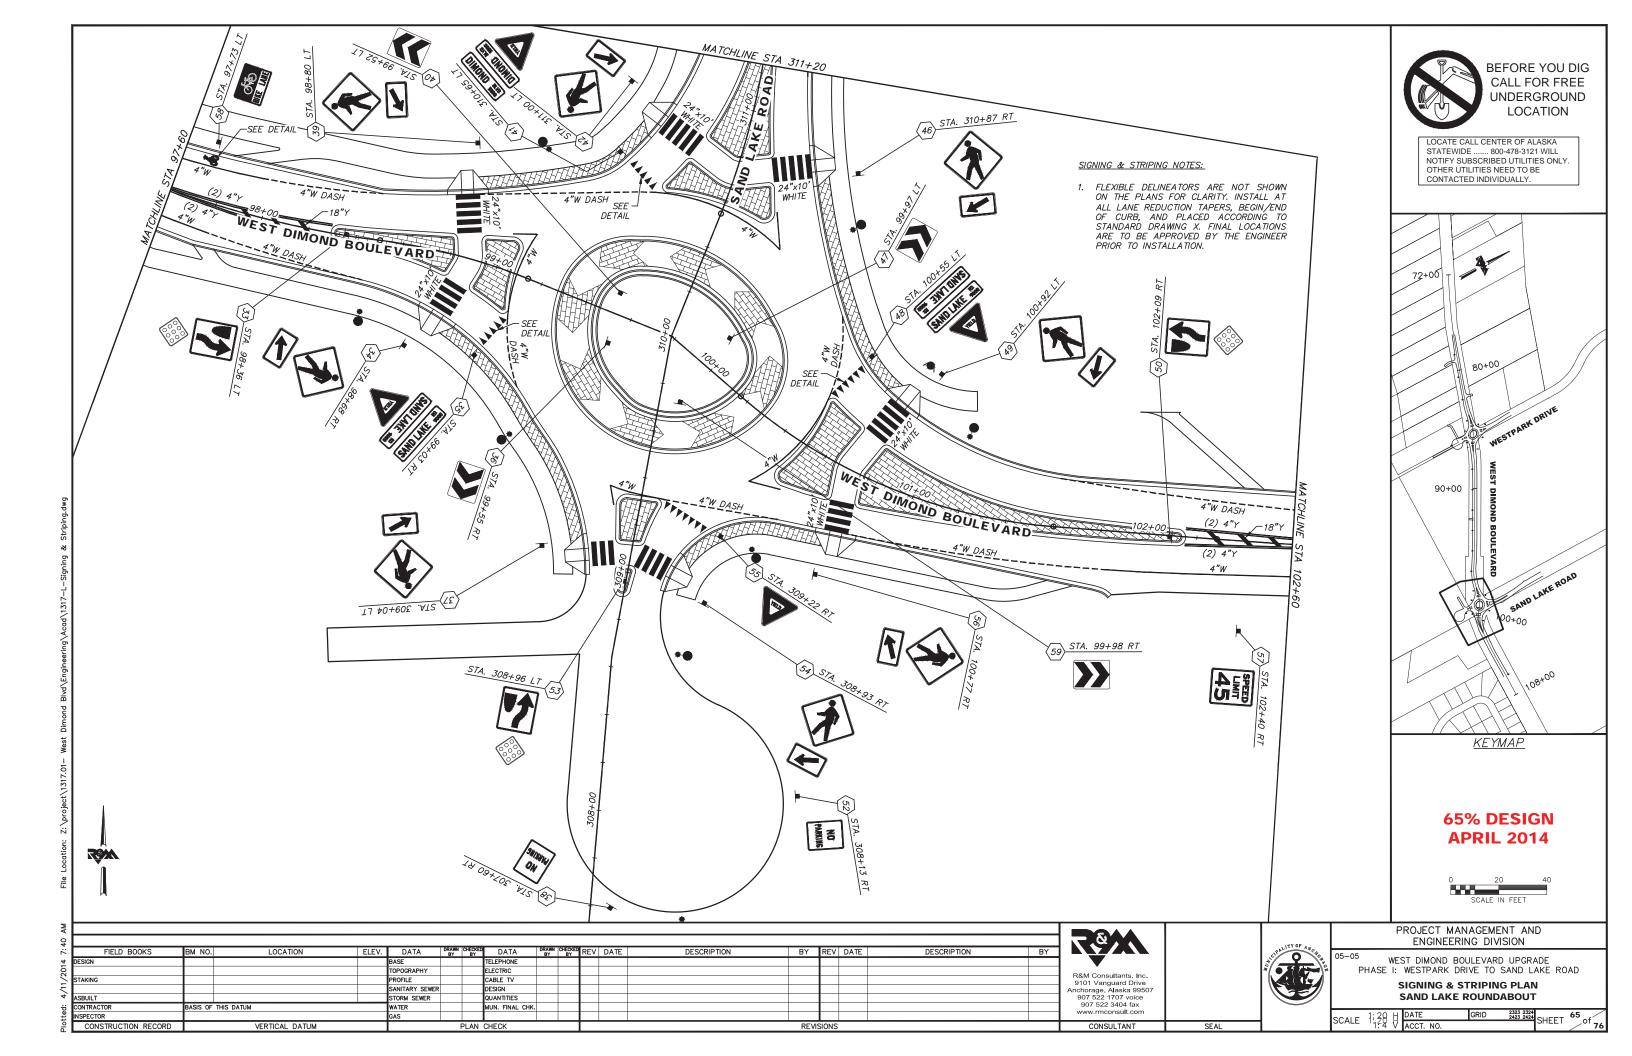


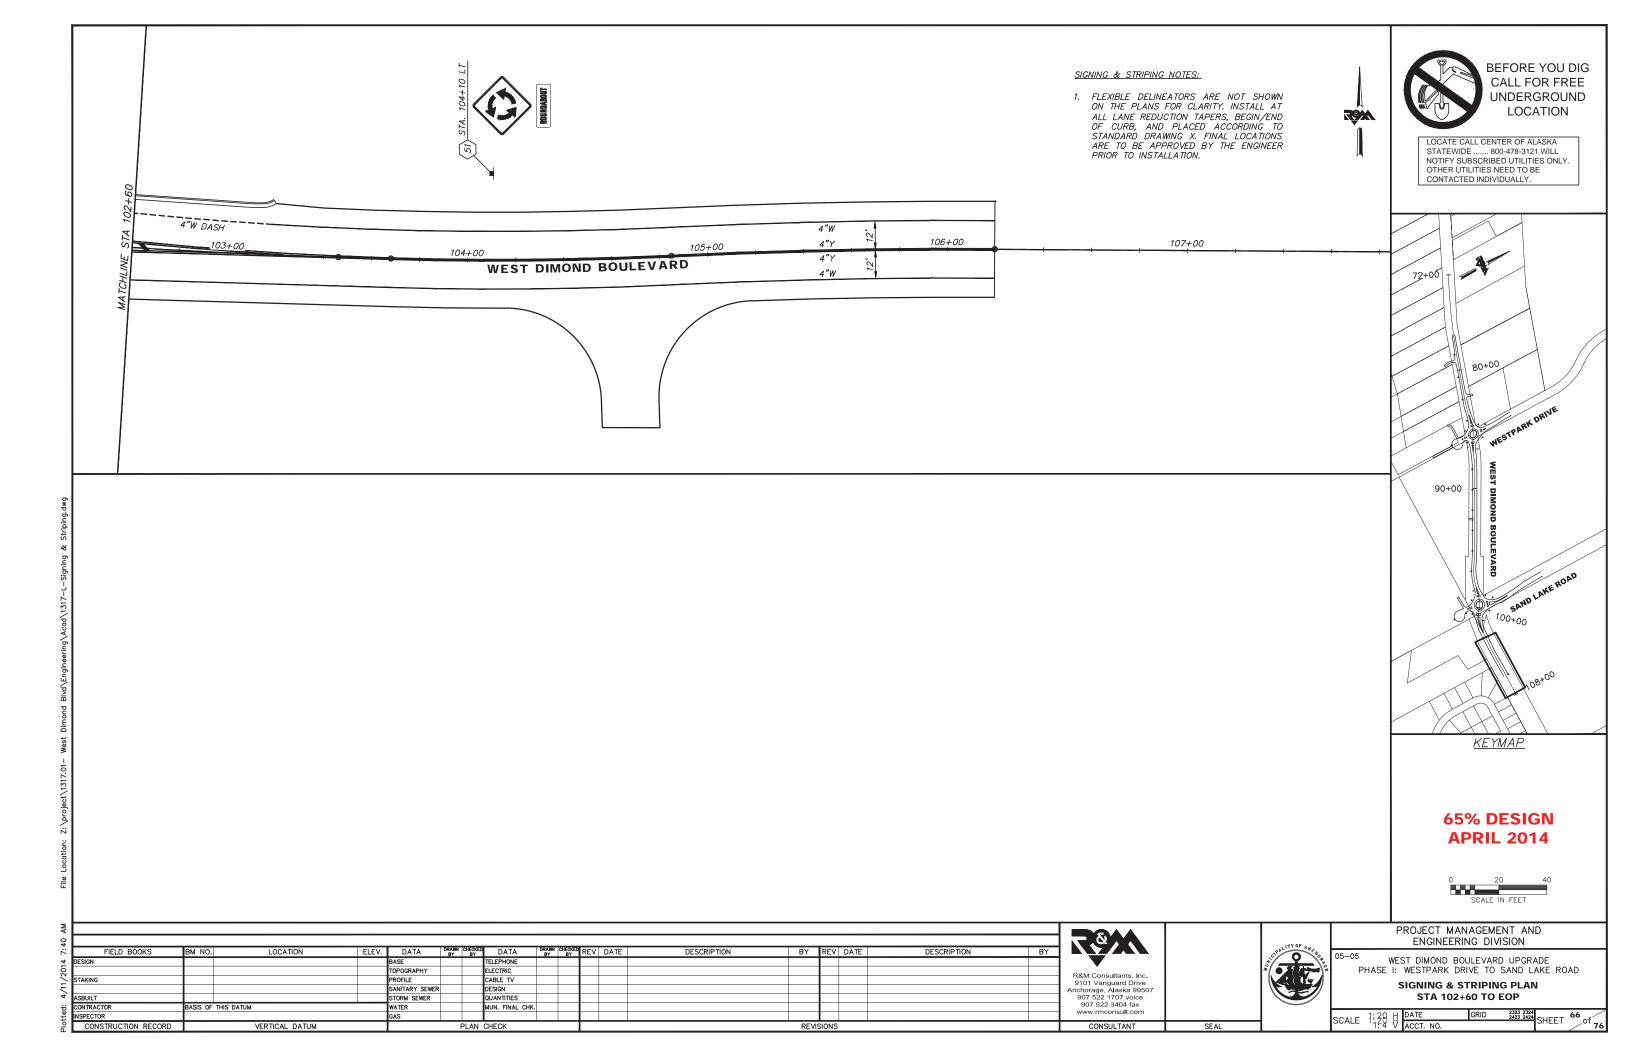

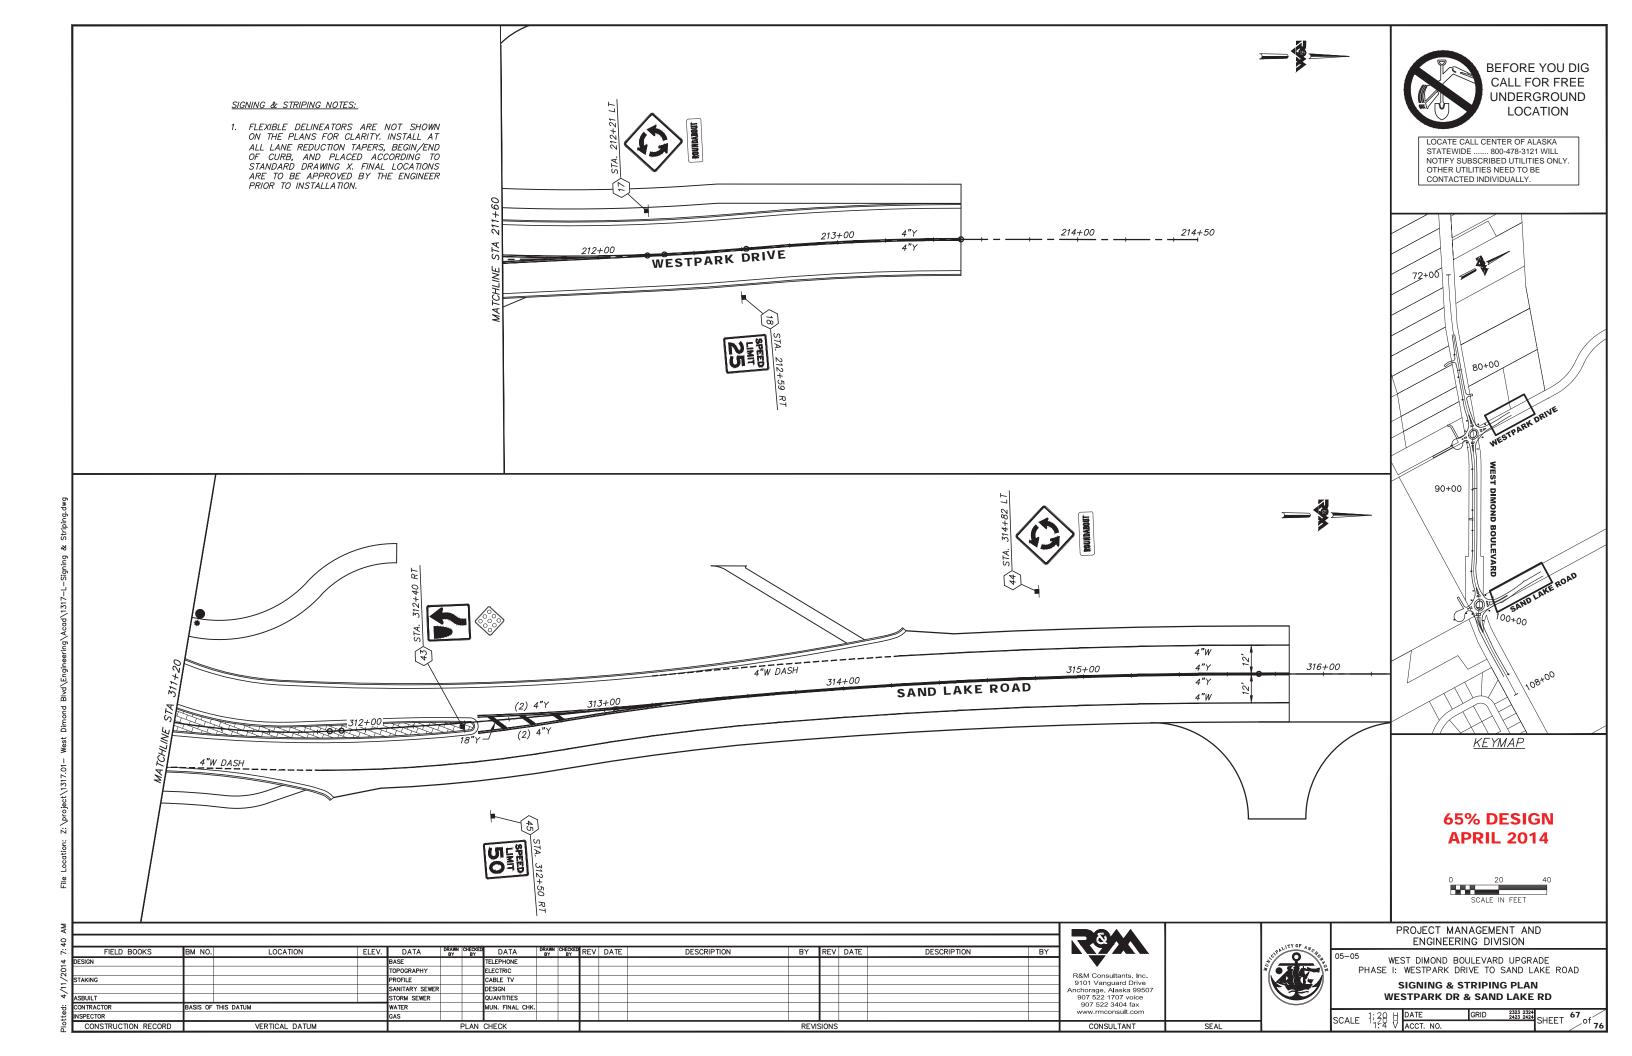

STRIPING MATERIALS LEGEND:

**INLAID MMA 90 MILS** 

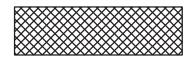

**INLAID MMA 125 MILS** 



**INLAID MMA 500 MILS** 

STRIPING MATERIALS AND APPLICATION KEY MAP

## 65% DESIGN APRIL 2014

R&M Consultants Inc.

R&M Consultants, Inc. 9101 Vanguard Drive Anchorage, Alaska 99507 907 522 1707 voice 907 522 3404 fax www.rmconsult.com



PROJECT MANAGEMENT AND ENGINEERING DIVISION

05 WEST DIMOND BOULEVARD UPGRADE PHASE I: WESTPARK DRIVE TO SAND LAKE ROAD

STRIPING MATERIALS AND APPLICATION KEY MAP

SCALE DATE GRID 2323 2324 SHEET 68 01 76

SIGN SUMMARY

## 65% DESIGN APRIL 2014

49																	;
ë	FIELD BOOKS	BM NO. LOCATION	ELEV.	DATA	DRAWN CH BY	HECKED BY	DATA	DRAWN C	HECKED BY	REV	DATE	DESCRIPTION	BY	REV	DATE	DESCRIPTION B	ΙΥ
4	DESIGN			BASE			TELEPHONE		$\Box$								
- S l				TOPOGRAPHY			ELECTRIC										
- 21	STAKING			PROFILE			CABLE TV										
₹Ι				SANITARY SEWER			DESIGN			'							Ar
4.	ASBUILT			STORM SEWER			QUANTITIES			'							
		BASIS OF THIS DATUM		WATER			MUN. FINAL CHK.										
₽ I	INSPECTOR			GAS					$\Box$								
8	CONSTRUCTION RECORD	VERTICAL DATUM			Pl	LAN	CHECK						REVIS	SIONS			

R&M Consultants, Inc. 9101 Vanguard Drive

CONSULTANT

R&M Consultants, Inc. 9101 Vanguard Drive Anchorage, Alaska 99507 907 522 1707 voice 907 522 3404 fax www.rmconsult.com

SEAL




PROJECT MANAGEMENT AND ENGINEERING DIVISION

5-05 WEST DIMOND BOULEVARD UPGRADE PHASE I: WESTPARK DRIVE TO SAND LAKE ROAD

SIGN SUMMARY TABLE

ALE	DATE	GRID	2323 2324 2423 2424	CHEET	69/
ALE	ACCT. NO.			SHEET	OI 76

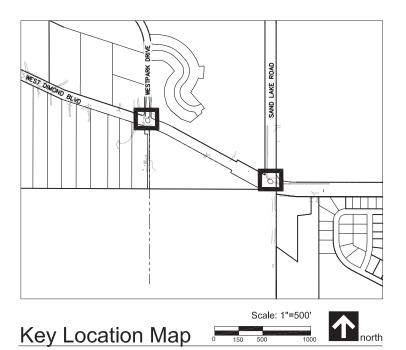

# Plant Schedule

		Quar	itity	Spacina	_	
Common Name	Botanical Name	Roundabouts	Wall opt.	(min.) _	Size	Notes
Trees						
Birch	Betula papyrifera	20	2	8' o.c.	3"-4" cal.	See note 2
Crabapple	Malus baccata		1	as shown	3" cal.	
Spruce	Picea glauca	16	0	8' o.c.	6' tall	Nursery grown
Shrubs						
Dogwood, Red Twig	Cornus sericea	82	0	4' o.c.	36" tall	
Lilac	Syringa vulgaris		5	4' o.c.	36" tall	
Spirea, Goldflame	Spirea bumalda 'Goldflame'	240	41	2' 0.c.	24" tall	
Perennials				•	•	•
Mixed species (Iris, Bergenia, Salvia, Lily, & Yarrow)		0	540	12"0.c.	l gal.	


#### Notes

- I. All plants shall meet American Standard for Nursery Stock (ANSI) Z60.1-2004 (American Nursery & Landscape Association (ANLA) 1200 G St., NW, Suite 800 Washington, DC 20005 www.anla.org)
- 2. Birch to be 50% single stem and 50% Birch, Clump. Birch, Clump to include birch with min. 3 trunks with 3 to 4 inch calipers each. All Birch shall be full with a canopy no less than one half the overall height.
- 3. Mulch continuously throughout all planting beds with 3" shredded bark mulch. Keep mulch 6" away from stems and trunks. Transition mulch to edging and adjacent surfaces. See mulch limit detail.
- 4. Topsoil and seed all disturbed areas, see civil for work limits. DO NOT SEED PLANTING BEDS. Topsoil depth shall be 4". On 2:1 and steeper slopes use BFM & MASS Schedule B (between path and ROW) and MASS Schedule D (between path
- 5. See planting details for additional information.
- 6. Height to spread ratio of evergreen trees equal 5 (height):3 (spread). Evergreens to be fully branched to ground.

### **Boulder Schedule**


Symbol	Туре	Size	Quantity
0	Large	4'x5'x5'	1
80	Medium	3'x3'x4'	4
8	Small	2'x3'x3'	4


See Detail 2, Sheet 75. Location and orientation to be under direction of the Landscape Architect. Boulders to be gray to dark gray angular rock with natural fractures. Drill holes shall not be visible.

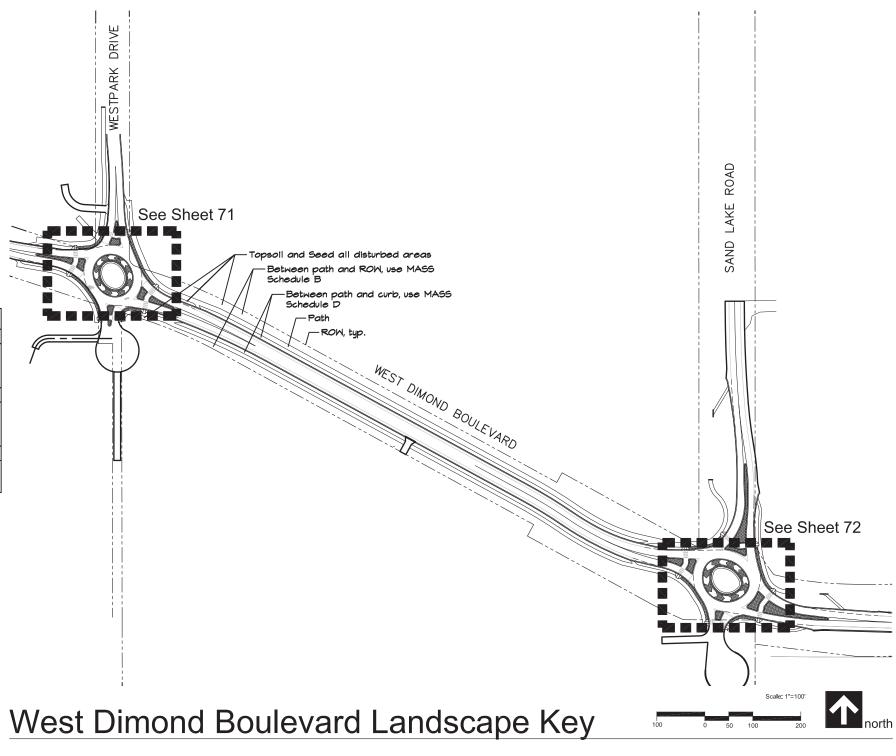

65% DESIGN **APRIL 2014** 

- 1																	
AM [																	PROJECT MANAGEMENT AND
= L																, 1TY OF A 1.	ENGINEERING DIVISION
6	FIELD BOOKS	BM NO. LOCATION	ELEV.	DATA	BY BY	DATA	BY BY	REV DATE	DESCRIPTION	BY	REV DATE	DESCRIPTION	BY			CIPAL	05_05
4 □	SIGN		В	BASE		TELEPHONE											WEST DIMOND BOULEVARD UPGRADE
8 F				TOPOGRAPHY		ELECTRIC										*/ <b>                                   </b>	PHASE I: WESTPARK DRIVE TO SAND LAKE ROAD
> S	AKING		P	PROFILE		CABLE TV								earthscape			
₹Γ			S	SANITARY SEWER	1	DESIGN								cartinocape			LANDSCAPE PLAN
4, 🛚	BUILT		s	STORM SEWER		QUANTITIES											
÷	NTRACTOR	BASIS OF THIS DATUM WATER MUN. FINAL CHK.												0707 0704			
± te	SPECTOR		G	GAS													SCALE DATE 4/10/14 GRID 2323 2324 SHEET 70 of 70
	CONSTRUCTION RECORD	CTION RECORD VERTICAL DATUM PLAN CHECK							REV	ISIONS			CONSULTANT	SEAL		ACCT. NO.	

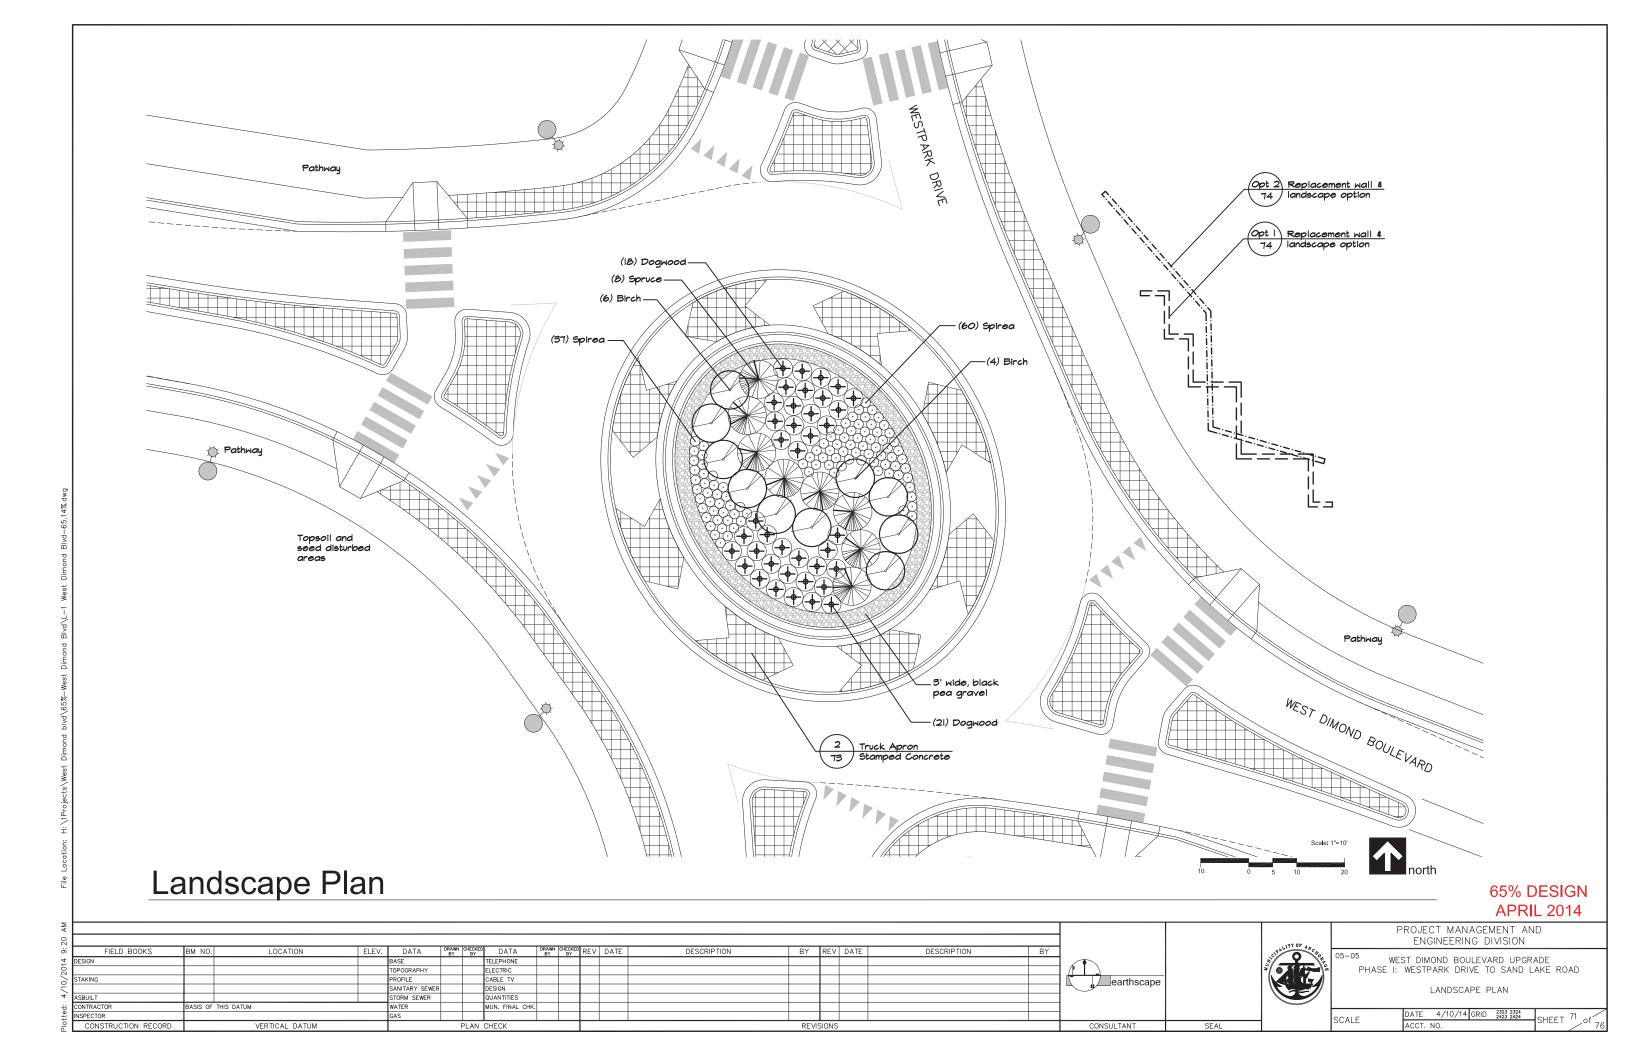


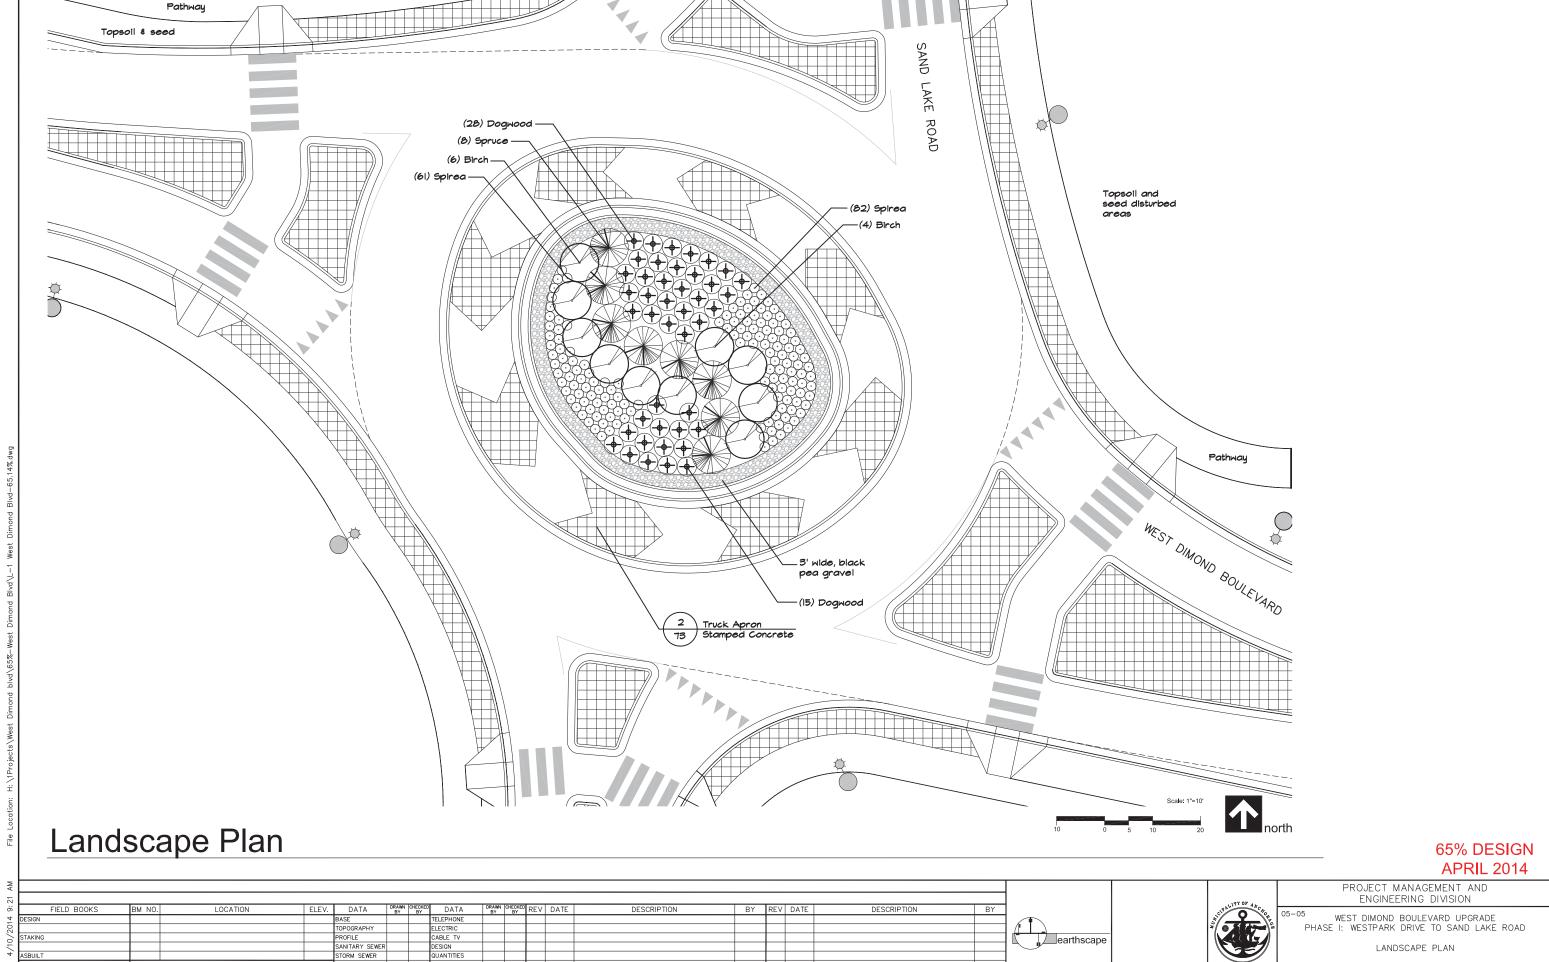

PROFILE SANITARY SEWER STORM SEWER

<sup>05</sup> WEST DIMOND BOULEVARD UPGRADE PHASE I: WESTPARK DRIVE TO SAND LAKE ROAD

SCALE

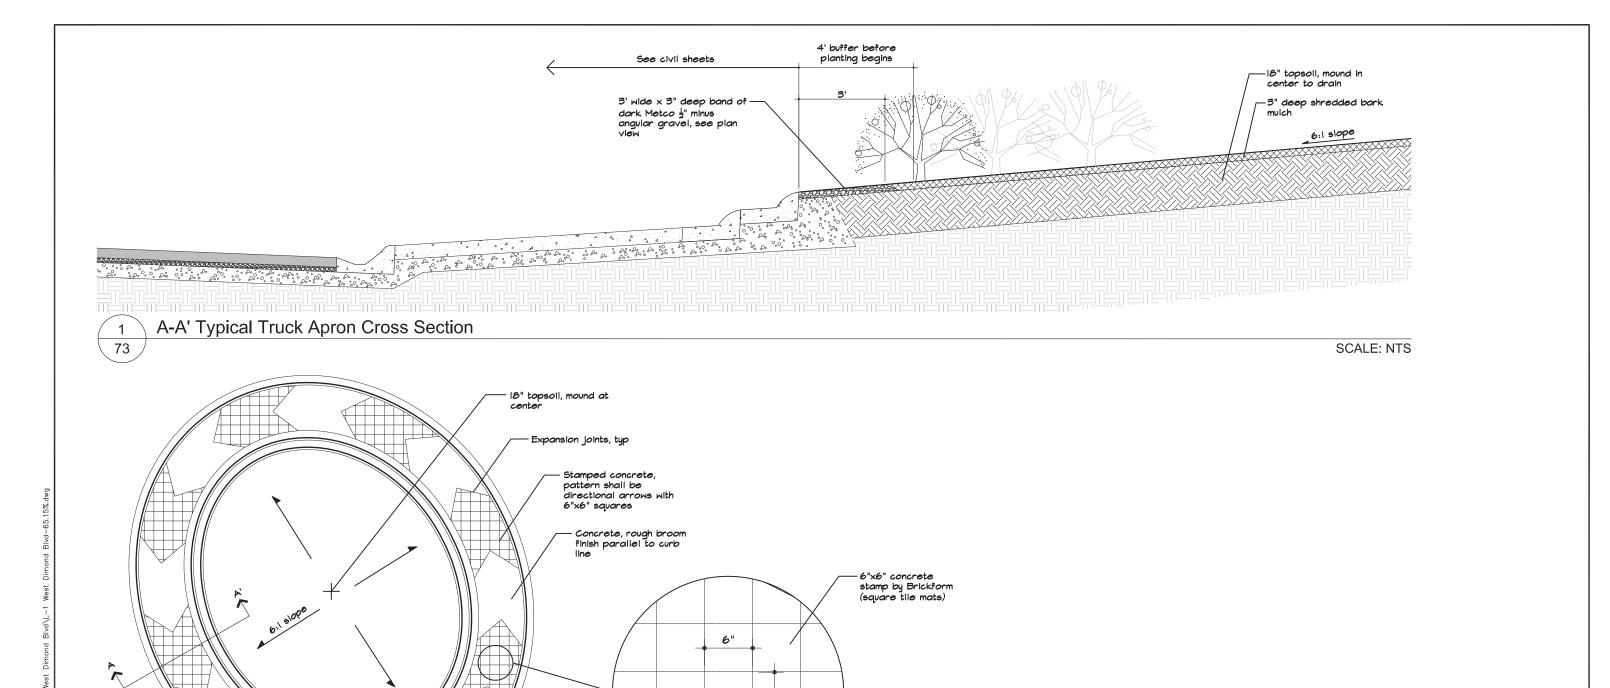

Truck Apron Paving Pattern


2 Truck

Truck Apron Plan (Stamped Concrete)


SCALE: NTS


65% DESIGN APRIL 2014

																7 (1 (1 (1	2 20 1 1
23 AM														TTY OF A.		PROJECT MANAGEMENT AN ENGINEERING DIVISION	ND
o⊓ FIELD BOOKS	BM NO. LOCATION ELEV.	DATA	DRAWN CHECKED	DATA	DRAWN CHECKER	REV DATE	DESCRIPTION	BY	REV DATE	DESCRIPTION	BY			CIPAL TOPO	05-05		
4 DESIGN		BASE		TELEPHONE								1 🗥		<u>*</u> */_ <b>Y</b> _\*	, I	WEST DIMOND BOULEVARD UPGR	RADE
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Ashlar Blend Pattern

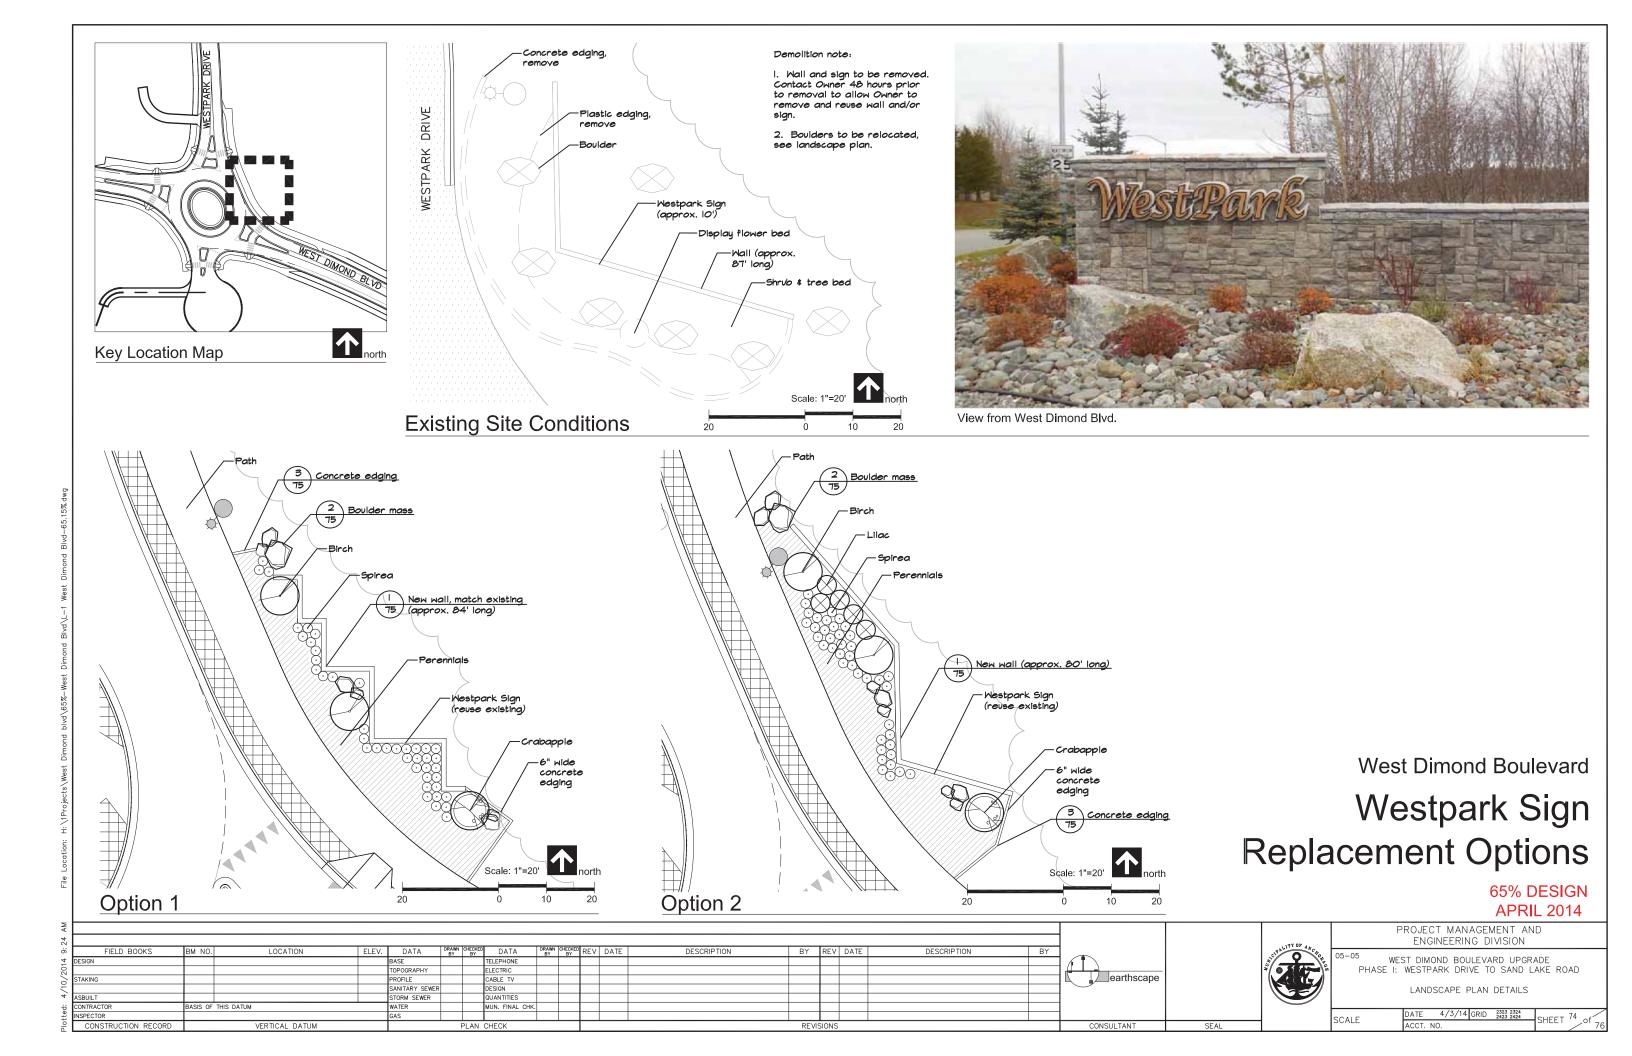

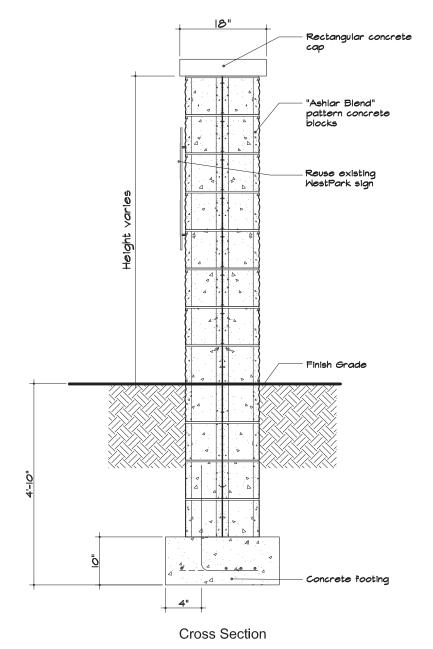

Bury Rocks 1/3 -1/2. Place rocks as shown on plans. All rocks to abut one another. Engineer to supervise placement. Rocks to be angular, varied diameters, minimum one 4-foot tall rock per mass, with natural appearing fractures and exposed faces.

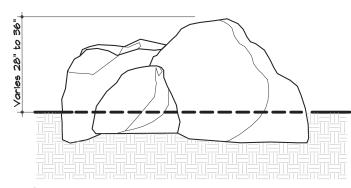SCALE: NTS

**Boulder Detail** 75

-6" PCC Curb, construction joints every 10-feet Topsoil & Seed, Lawn, typ. Type IIA Classified Fill compact to 95% -Planting Bed - 18" topsoil depth Compacted subgrade

Concrete Edging Detail 75 SCALE: NTS



Elevation


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Replacement Sign Detail

SCALE: NTS

65% DESIGN **APRIL 2014** 

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PROJECT MANAGEMENT AND ENGINEERING DIVISION


<sup>05</sup> WEST DIMOND BOULEVARD UPGRADE PHASE I: WESTPARK DRIVE TO SAND LAKE ROAD

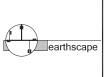LANDSCAPE PLAN DETAILS

DATE 4/10/14 GRID 2323 2324 ACCT. NO. SHEET 75

SEAL

SCALE

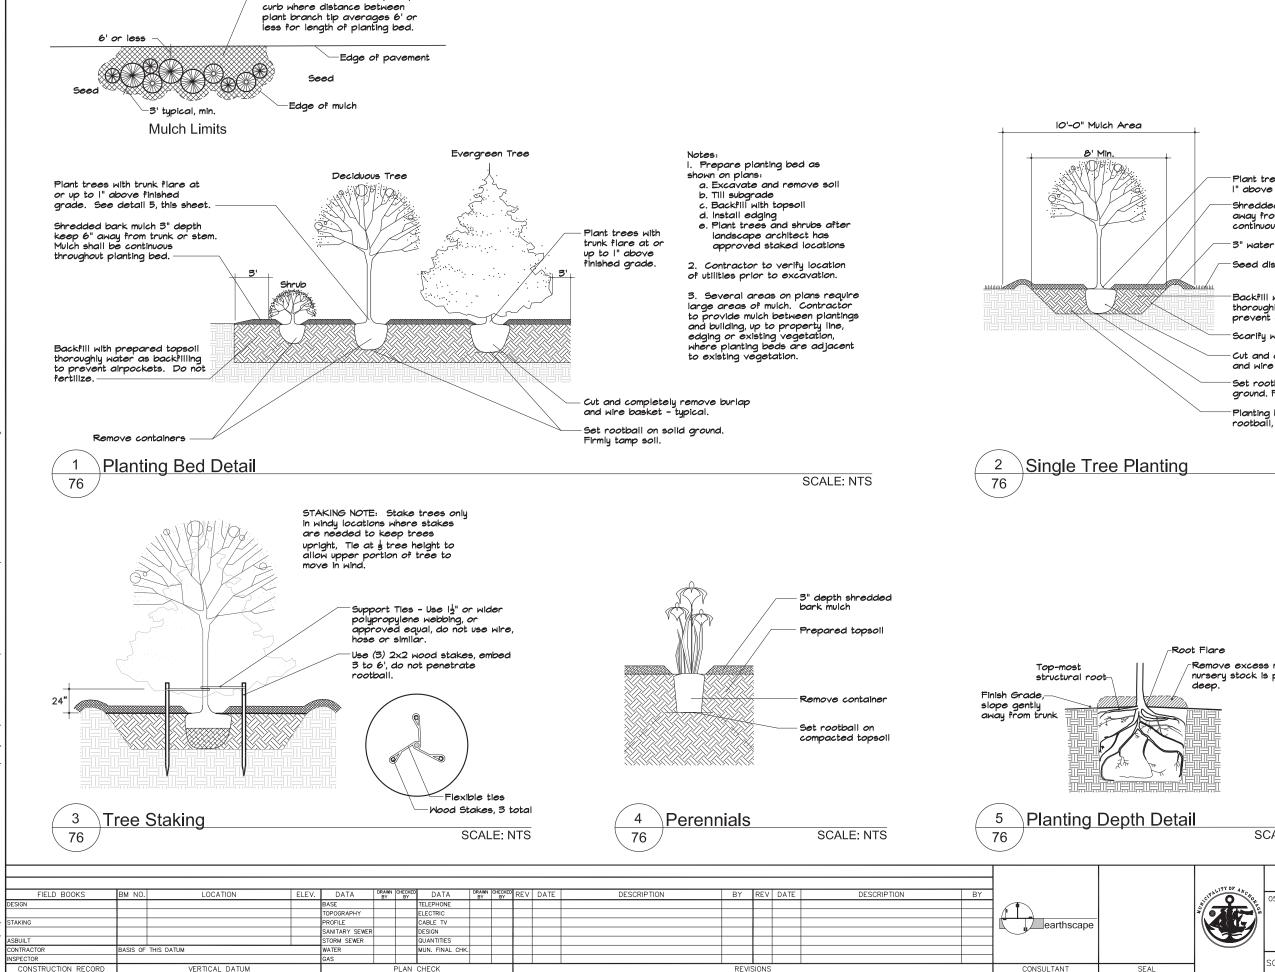

Extend mulch to sidewalk, trail, or

Plant trees with trunk flare at or up to I" above finished grade. Shredded bark mulch 3" depth keep 6" away from trunk or stem. Mulch shall be continuous throughout planting bed. 3" water basin, hand-compacted Seed disturbed areas Backfill with prepared topsoil thoroughly water as backfilling to prevent airpockets. Do not fertilize. Scarify walls and bottom of plant pit Cut and completely remove burlap and wire basket - typical. Set rootball on solid ground. Firmly tamp soil. Planting bed to be 3x rootball, no less than 8'

Remove excess material, if nursery stock is planted too

SCALE: NTS

65% DESIGN **APRIL 2014** 

PROJECT MANAGEMENT AND ENGINEERING DIVISION

SCALE: NTS

<sup>)5</sup> WEST DIMOND BOULEVARD UPGRADE PHASE I: WESTPARK DRIVE TO SAND LAKE ROAD

LANDSCAPE PLAN DETAILS

DATE 4/10/14 GRID 2323 2324 2423 2424 SHEET 76 SCALE